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3/8"=1'-0"

FAIRFIELD ELEMENTARY
1313 EASTFIELD ROAD
MAUMEE, OHIO 43537




MAUMEE CITY SCHOOLS ADMINISTRATIVE OFFICE
716 Askin Street
Maumee, OH 43537

BOARD MEMBERS


MS. STEPHANIE PIECHOWIAK - PRESIDENT
MS. JANET WOLFF - VICE PRESIDENT
MS. DIANE BALCERZAK
MS. JENNIFER CAMPOS
MR. MIKE WILEY

STAFF MEMBERS

TODD CRAMER - SUPERINTENDENT
STEVEN LEE - ASSISTANT SUPERINTENDENT
PAUL BROTZKI - TREASURER
NICK NEIDERHOUSE - PRINCIPAL WAYNE TRAIL
MICHELE LOBOSCHEFSKI - PRINCIPAL FAIRFIELD

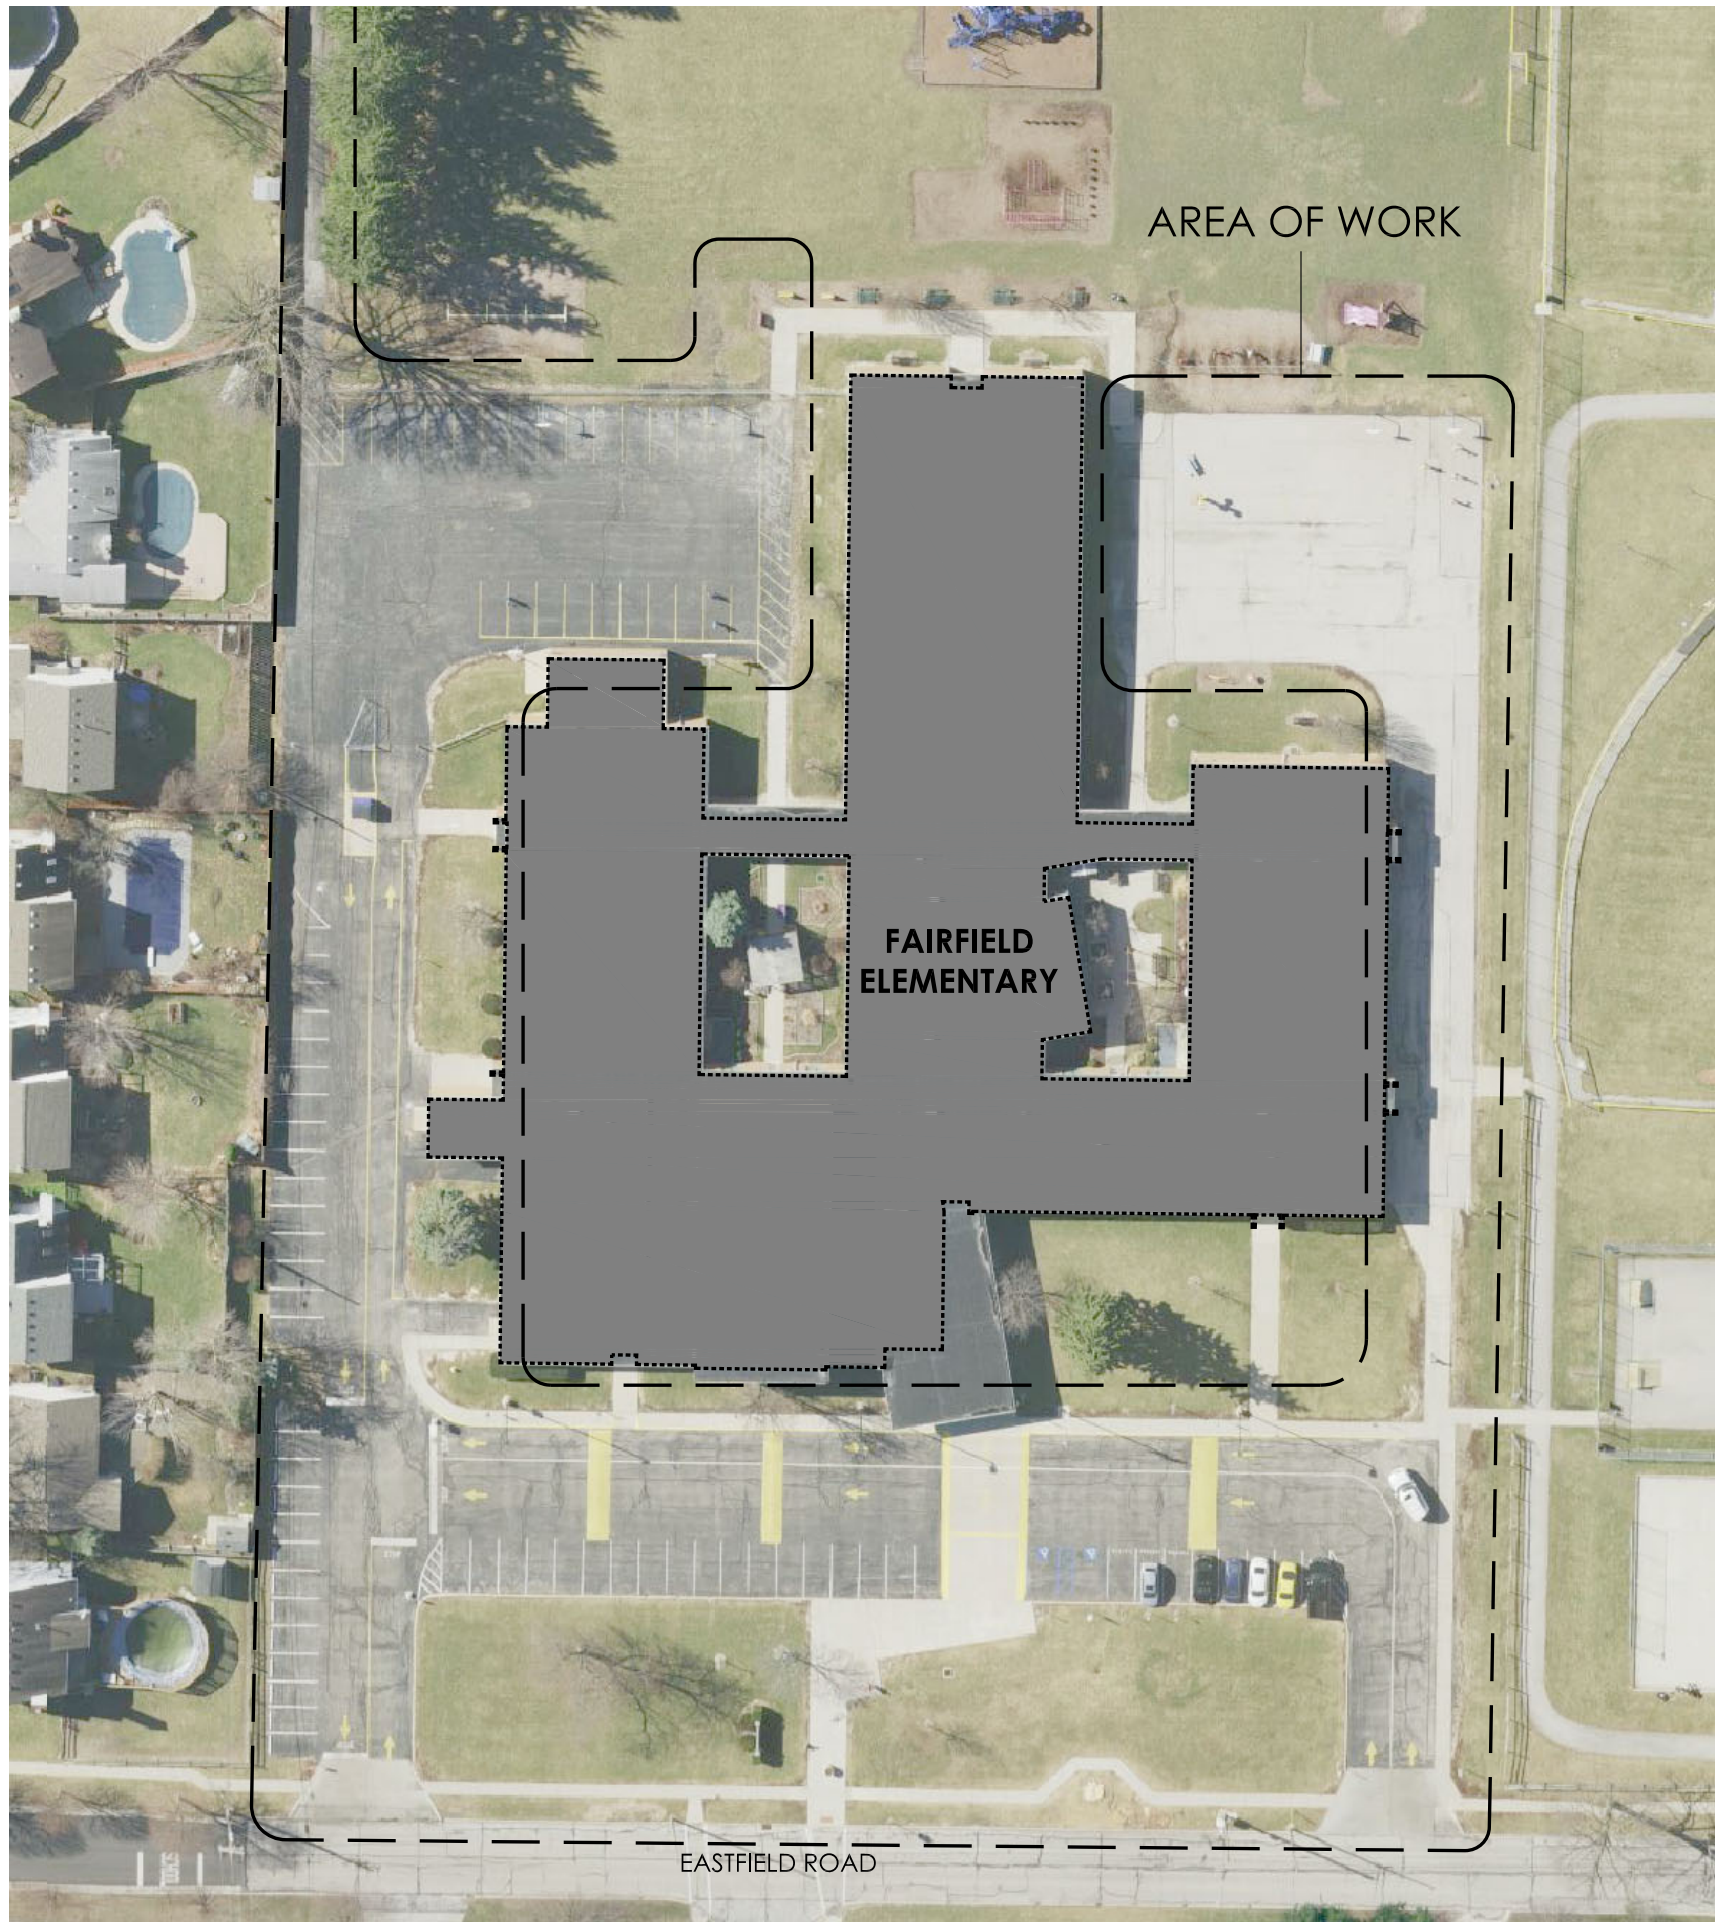

EXISTING AERIAL PHOTO - FAIRFIELD ELEMENTARY
NO SCALE

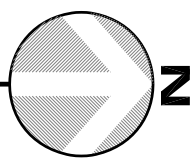

MAUMEE CITY SCHOOLS SUMMER PAVING PROJECTS

INDEX OF DRAWINGS

ISSUED:	ISSUED:	ISSUED:
□ □ ■	T1.0	TITLE SHEET
□ □ ■	C0.0	FAIRFIELD ELEMENTARY TOPO SURVEY (FOR REFERENCE ONLY)
□ □ ■	C0.1	WAYNE TRAIL ELEMENTARY TOPO SURVEY (FOR REFERENCE ONLY)
□ □ ■	D1.0	FAIRFIELD EXIST. CONDITIONS/DEMO SITE PLAN
□ □ ■	D1.1	FAIRFIELD EXIST. PHOTOS & DEMO NOTES
□ □ ■	D2.0	WAYNE TRAIL EXIST. CONDITIONS/DEMO SITE PLAN
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□ □ ■	C2.0	WAYNE TRAIL ELEMENTARY SITE UTILITY & EROSION CONTROL PLAN
□ □ ■	C2.1	WAYNE TRAIL ELEMENTARY SITE GRADING PLAN
□ □ ■	C3.0	NOTES AND DETAILS
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□ □ ■	A3.0	SITE PAVEMENT DETAILS
□ □ ■	A3.1	ENLARGED PLAN DETAILS
□ □ ■	A3.2	NOTES AND DETAILS



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DRAWING SYMBOL:	DESCRIPTION:	DRAWING SYMBOL:	DESCRIPTION:
	INDICATES ELEVATION CHANGE OR BEARING HEIGHT		STANDARD DETAIL SYMBOL: INDICATES DETAIL NUMBER INDICATES SHEET NUMBER
	INDICATES REVISION NUMBER		DIVISION INDICATOR
	REVISION CLOUD		SITE PLAN KEY NOTE
	INDICATES CENTER LINE OF ITEM OR AREA		DEMO PLAN KEY NOTE
	STANDARD NORTH ARROW (TRUE NORTH)		SIGN TYPE KEY NOTE
	STANDARD NORTH ARROW (PROJECT NORTH)		STANDARD SECTION SYMBOL: INDICATES SECTION NUMBER INDICATES SHEET NUMBER
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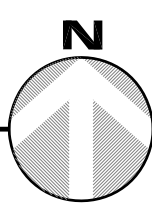
WAYNE TRAIL ELEMENTARY
1147 7TH STREET
MAUMEE, OHIO 43537



LOCATION MAP
NO SCALE



EXISTING AERIAL PHOTO - WAYNE TRAIL ELEMENTARY
NO SCALE

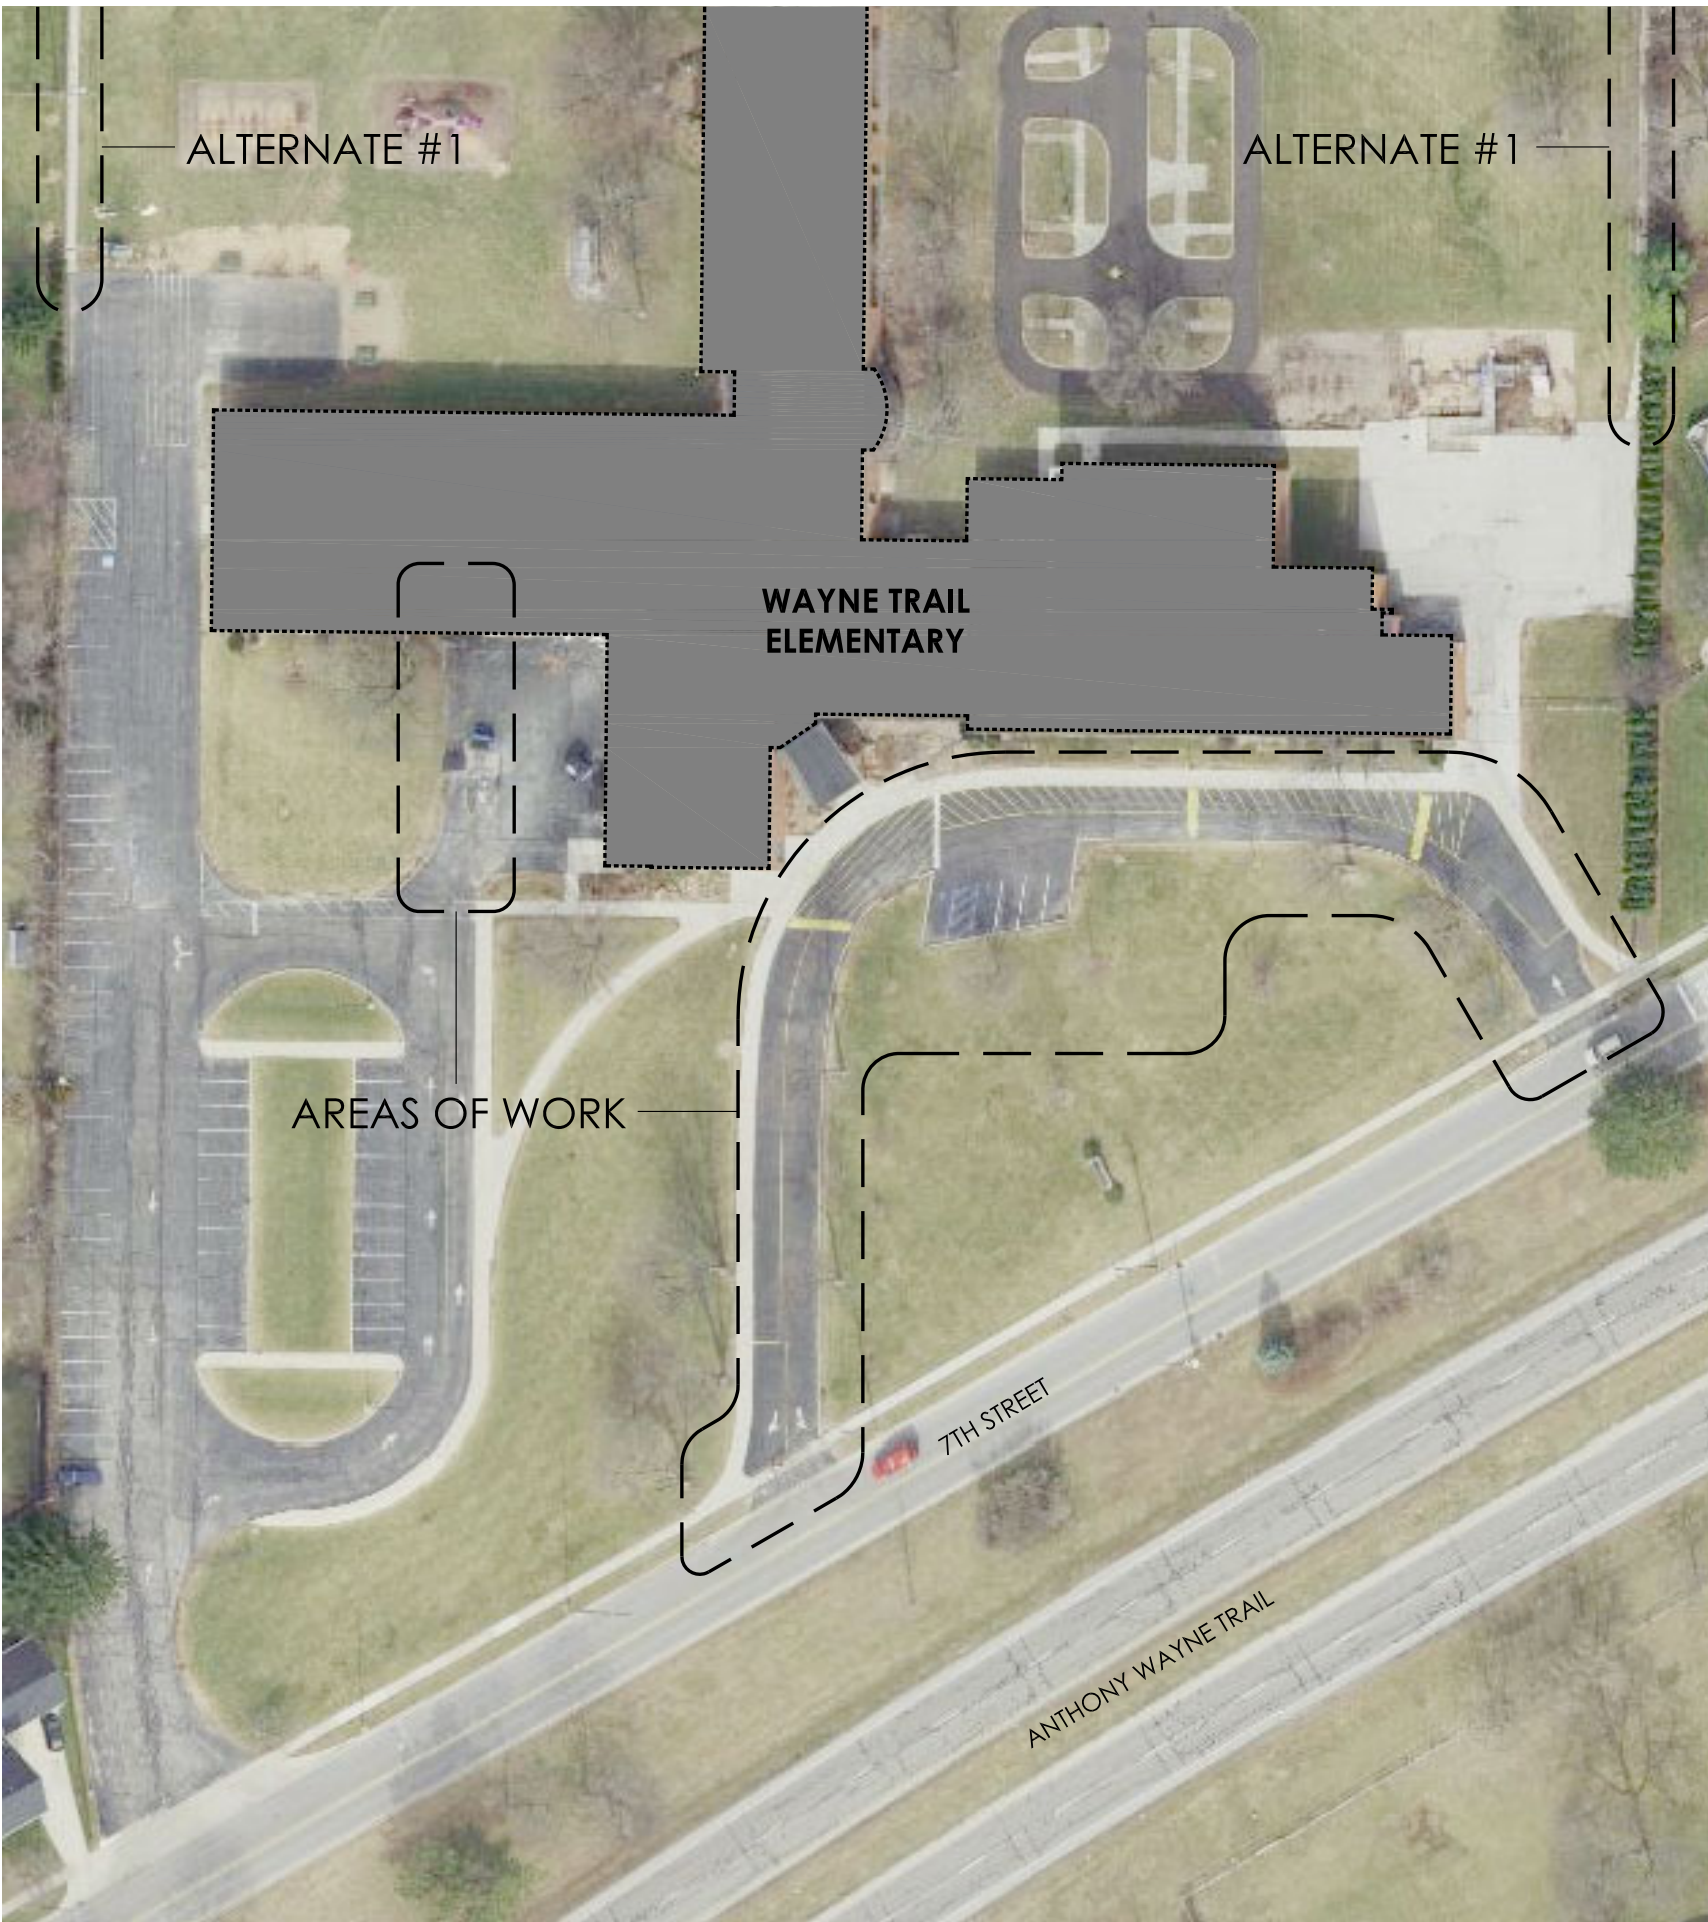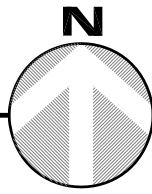


8 North St. Clair - Toledo, Ohio 43604-1028
1 419.243.2400
www.thomasporterarchitects.com

CONSULTANTS:

esa
Engineers, Surveyors & Associates, LLC
5353 Secor Rd., Toledo, Ohio 43623 Phone (419) 475-9445

SEAL:

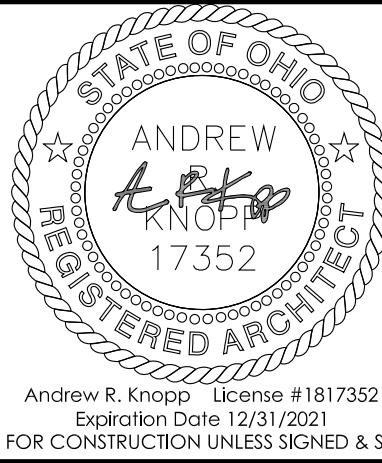

WAYNE TRAIL ELEMENTARY
1147 7TH STREET
MAUMEE, OHIO 43537

SUMMER PAVING PROJECTS
MAUMEE CITY SCHOOLS

FAIRFIELD ELEMENTARY
1313 EASTFIELD ROAD
MAUMEE, OHIO 43537

PROJECT TITLE:

ISSUE OR REVISION:

03.05.2020 BID DOCUMENTS

DATE ISSUE / REVISION

DESIGNED: ACH

DRAWN: ACH

CHECKED: JEA

TPA COMMISSION NUMBER: 19060

DRAWING TITLE:

TITLE SHEET

DRAWING NUMBER:

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PARCEL: 3600194
OWNER: CITY OF MAUMEE
ADDRESS: 3215 EASTFIELD DR

PARCEL: 3600131
OWNER: CITY OF MAUMEE
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PARCEL: 3660288
OWNER: GREAT LAKES HOMES INC
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PARCEL: 3600191
OWNER: MAUMEE CITY BOARD OF ED
ADDRESS: 3213 EASTFIELD DR

PARCEL: 3600901
OWNER: LECK DONALD C JR & DIANE M
ADDRESS: 1644 CASS RD

PARCEL: 3660891
OWNER: DARRAH JON & JULIA
ADDRESS: 1277 WESTFIELD DR

PARCEL: 3660894
OWNER: EAST JAY M & JULIE M
ADDRESS: 501 CENTERFIELD DR

PARCEL: 3660897
OWNER: JACOBS ROBERT JEFFERY
& PATRICIA L
ADDRESS: 505 CENTERFIELD DR

PARCEL: 3660901
OWNER: SHOOLA AYODEJI F
& TONI N
ADDRESS: 511 CENTERFIELD DR

PARCEL: 3660904
OWNER: PHILLIPS ERIC G
ADDRESS: 515 CENTERFIELD D

PARCEL: 3660907
OWNER: COMMAGER ROGER J
& JULIE A
ADDRESS: 521 CENTERFIELD DR

PARCEL: 3660911
OWNER: DOLLEY STEPHEN R
& LINDA M
ADDRESS: 525 CENTERFIELD DR

PARCEL: 3660914
OWNER: ADAMS MIGNON PERRIN
ADDRESS: 531 CENTERFIELD DR

PARCEL: 3660917
OWNER: BURDGE BRYAN E SR
& CHARLENE D
ADDRESS: 535 CENTERFIELD DR

LEGEND

	AIR CONDITION UNIT		GAS VALVE		EXISTING SPOT ELEVATION
	BUSH		GUY WIRE		EXISTING TOP/CURB
	CATCH BASIN ROUND		IRON PIN FOUND		EXISTING TOP/PVMT
	CATCH BASIN SQUARE		LIGHT POLE		EXISTING CONTOUR
	CLEANOUT		POWER POLE		UNDERGROUND ELECTRIC
	CONIFER TREE / (INCH)		SANITARY MANHOLE		UNDERGROUND CABLE
	CONTROL POINT		SIGN		FENCE LINE
	CURB INLET		SITE BENCHMARK		SANITARY SEWER LINE
	DECIDUOUS TREE / (INCH)		STEEL POST		STORM SEWER LINE
	DOWNSPOUT		STORM MANHOLE		GAS LINE
	ELECTRIC BOX		TRANSFORMER		WATER LINE
	ELECTRIC METER		TELEPHONE PEDESTAL		WATER MANHOLE
	ELECTRIC PEDESTAL		WATER METER		OVERHEAD UTIL. WIRES
	FIRE HYDRANT		WATER VALVE		UNDERGROUND TELEPHONE
	FLAG POLE		WOOD POST		
	GAS METER				

EXISTING UTILITY STRUCTURE SCHEDULE

STRUCTURE TYPE	ID	RIM	PIPE SIZE	PIPE MAT'L	DIRECTION	INVERT
EX. SAN. MANHOLE	133	632.06	10"	UNKNOWN	W	623.51
		632.06	10"	UNKNOWN	E	623.46
EX. CURB INLET	137	631.61	4"	PVC	SW	629.81
			BOTTOM			629.56
EX. CATCH BASIN	160	631.47	6"	VIT	N	627.87
		631.47	6"	VIT	S	627.87
EX. CATCH BASIN	343	631.18	4"	PVC	NW	629.68
		631.18	6"	VIT	S	628.48
EX. CATCH BASIN	438	631.09	4"	CPP	SW	629.54
		631.09	6"	VIT	N	627.59
		631.09	6"	VIT	NE	627.79
		631.09	10"	UNKNOWN	SW	627.59
EX. STORM MANHOLE	459	632.21	12"	RCP	N	626.46
		632.21	15"	RCP	W	626.31
EX. SAN. MANHOLE	486	632.72	FILLED WITH WATER		BOTTOM:	625.22
EX. STORM MANHOLE	718	632.44		UNKNOWN	SE	622.29
		632.44		UNKNOWN	NW	622.24
		632.44	15"	UNKNOWN	E	624.04

EXISTING UTILITY STRUCTURE SCHEDULE

STRUCTURE TYPE	ID	RIM	PIPE SIZE	PIPE MAT'L	DIRECTION	INVERT
EX. SAN. MANHOLE	724	631.69	30"	RCP	S	614.52
		631.69	36"	RCP	W	614.02
EX. STORM MANHOLE	841	632.36	15"	RCP	W	625.41
		632.36	12"	PVC	N	627.46
		632.36	15"	RCP	E	625.51
EX. CATCH BASIN	929	631.79	6"	VIT	S	628.79
EX. STORM MANHOLE	977	631.63	36"	RCP	S	622.28
		631.63	42"	RCP	W	622.18
EX. CATCH BASIN	1038	631	4"	PVC	S	629.70
		631	6"	PVC	E	629.30
EX. CATCH BASIN	2000	631.12	8"	PVC	N	628.72
		631.12	10"	PVC	E	628.82
		631.12	6"	PVC	SE	629.12
		631.12	12"	PVC	SW	628.42

EXISTING SEWER NOTE:
THE INVERTS AND PIPE SIZES SHOWN FOR THE EXISTING SEWERS ARE AS BEST DETERMINED WITHOUT ENTERING THE UTILITY STRUCTURES. THESE ELEVATIONS ARE BASED ON FIELD OBSERVATION MEASURED FROM THE RIM OF EACH STRUCTURE TO THE INVERT OF EACH PIPE INSIDE THE STRUCTURE. SOME ARE ESTIMATED DUE TO DEBRIS INSIDE THE STRUCTURE AND/OR THE PIPES BEING RECESSED AND NOT DIRECTLY AVAILABLE FOR DIRECT MEASURE.

SURVEYOR NOTE:
SURVEYOR HAS MADE NO INVESTIGATION OR INDEPENDENT SEARCH FOR EASEMENTS OF RECORD, ENCUMBRANCES, RESTRICTIVE COVENANTS, OWNERSHIP TITLE EVIDENCE, OR ANY OTHER FACTS THAT AN ACCURATE AND CURRENT TITLE SEARCH MAY DISCLOSE.

SITE BENCHMARK:
NORTH BONNET BOLT ON HYDRANT SHOWN
HEREIN. NAVD88 ELEVATION = 635.03



Know what's below.
Call before you dig.

UNDERGROUND UTILITIES OUPSTICKET#B930800476

UNDERGROUND UTILITIES AS SHOWN WERE LOCATED IN THE FIELD AND/OR TAKEN FROM VARIOUS DEPARTMENT RECORDS. THE LOCATIONS ARE AS ACCURATE AS WE CAN CONFIRM FROM SURFACE MANIFESTATIONS (E.G. VALVES, MANHOLES, ETC.), BUT NO EXCAVATION WAS DONE BY ESA ENGINEERS, SURVEYORS AND ASSOCIATES, LLC. THE EXACT LOCATION IS THE RESPONSIBILITY OF THE CONTRACTOR(S). BE SURE TO CALL THE OHIO UTILITIES PROTECTION SERVICE BEFORE STARTING ANY EXCAVATION AT 811.




8 North St. Clair - Toledo, Ohio 43604-1028
T 419.243.2400
www.thomasporterarchitects.com

CONSULTANTS:

ESA

Engineers, Surveyors & Associates, LLC
13333 Secor Rd., Toledo, Ohio, 43623 Phone (419) 475-9445

SEAL:

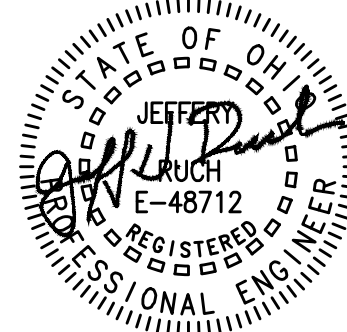

NOT FOR CONSTRUCTION UNLESS SIGNED & SEALED

SUMMER PAVING PROJECTS

MAUMEE CITY SCHOOLS

WAYNE TRAIL ELEMENTARY
1147 7TH STREET
MAUMEE, OHIO 43537

FAIRFIELD ELEMENTARY
1313 EASTFIELD ROAD
MAUMEE, OHIO 43537

PROJECT TITLE:

ISSUE OR REVISION:

3.05.2020	BID DOCUMENTS
2.21.2020	90% SUBMITTAL
DATE	ISSUE / REVISION
DESIGNED:	RGS,JHR
DRAWN:	RGS
CHECKED:	INITIALS

TPA COMMISSION NUMBER: 19060


DRAWING TITLE:

FAIRFIELD
ELEMENTARY
TOPO SURVEY

DRAWING NUMBER:

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EXISTING SEWER NOTE:
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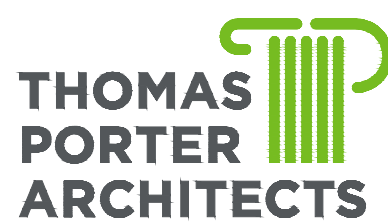
UNDERGROUND UTILITIES
UNDERGROUND UTILITIES AS SHOWN WERE LOCATED IN THE FIELD AND/OR TAKEN FROM VARIOUS DEPARTMENT RECORDS. THE LOCATIONS ARE AS ACCURATE AS WE CAN CONFIRM FROM SURFACE MANIFESTATIONS (E.G. VALVES, MANHOLES, ETC.), BUT NO EXCAVATION WAS DONE BY ESA ENGINEERS, SURVEYORS AND ASSOCIATES, LLC. THE EXACT LOCATION IS THE RESPONSIBILITY OF THE CONTRACTOR(S). BE SURE TO CALL THE OHIO UTILITIES PROTECTION SERVICE BEFORE STARTING ANY EXCAVATION AT 811. OUPSTICKET#A930801612

LEGEND

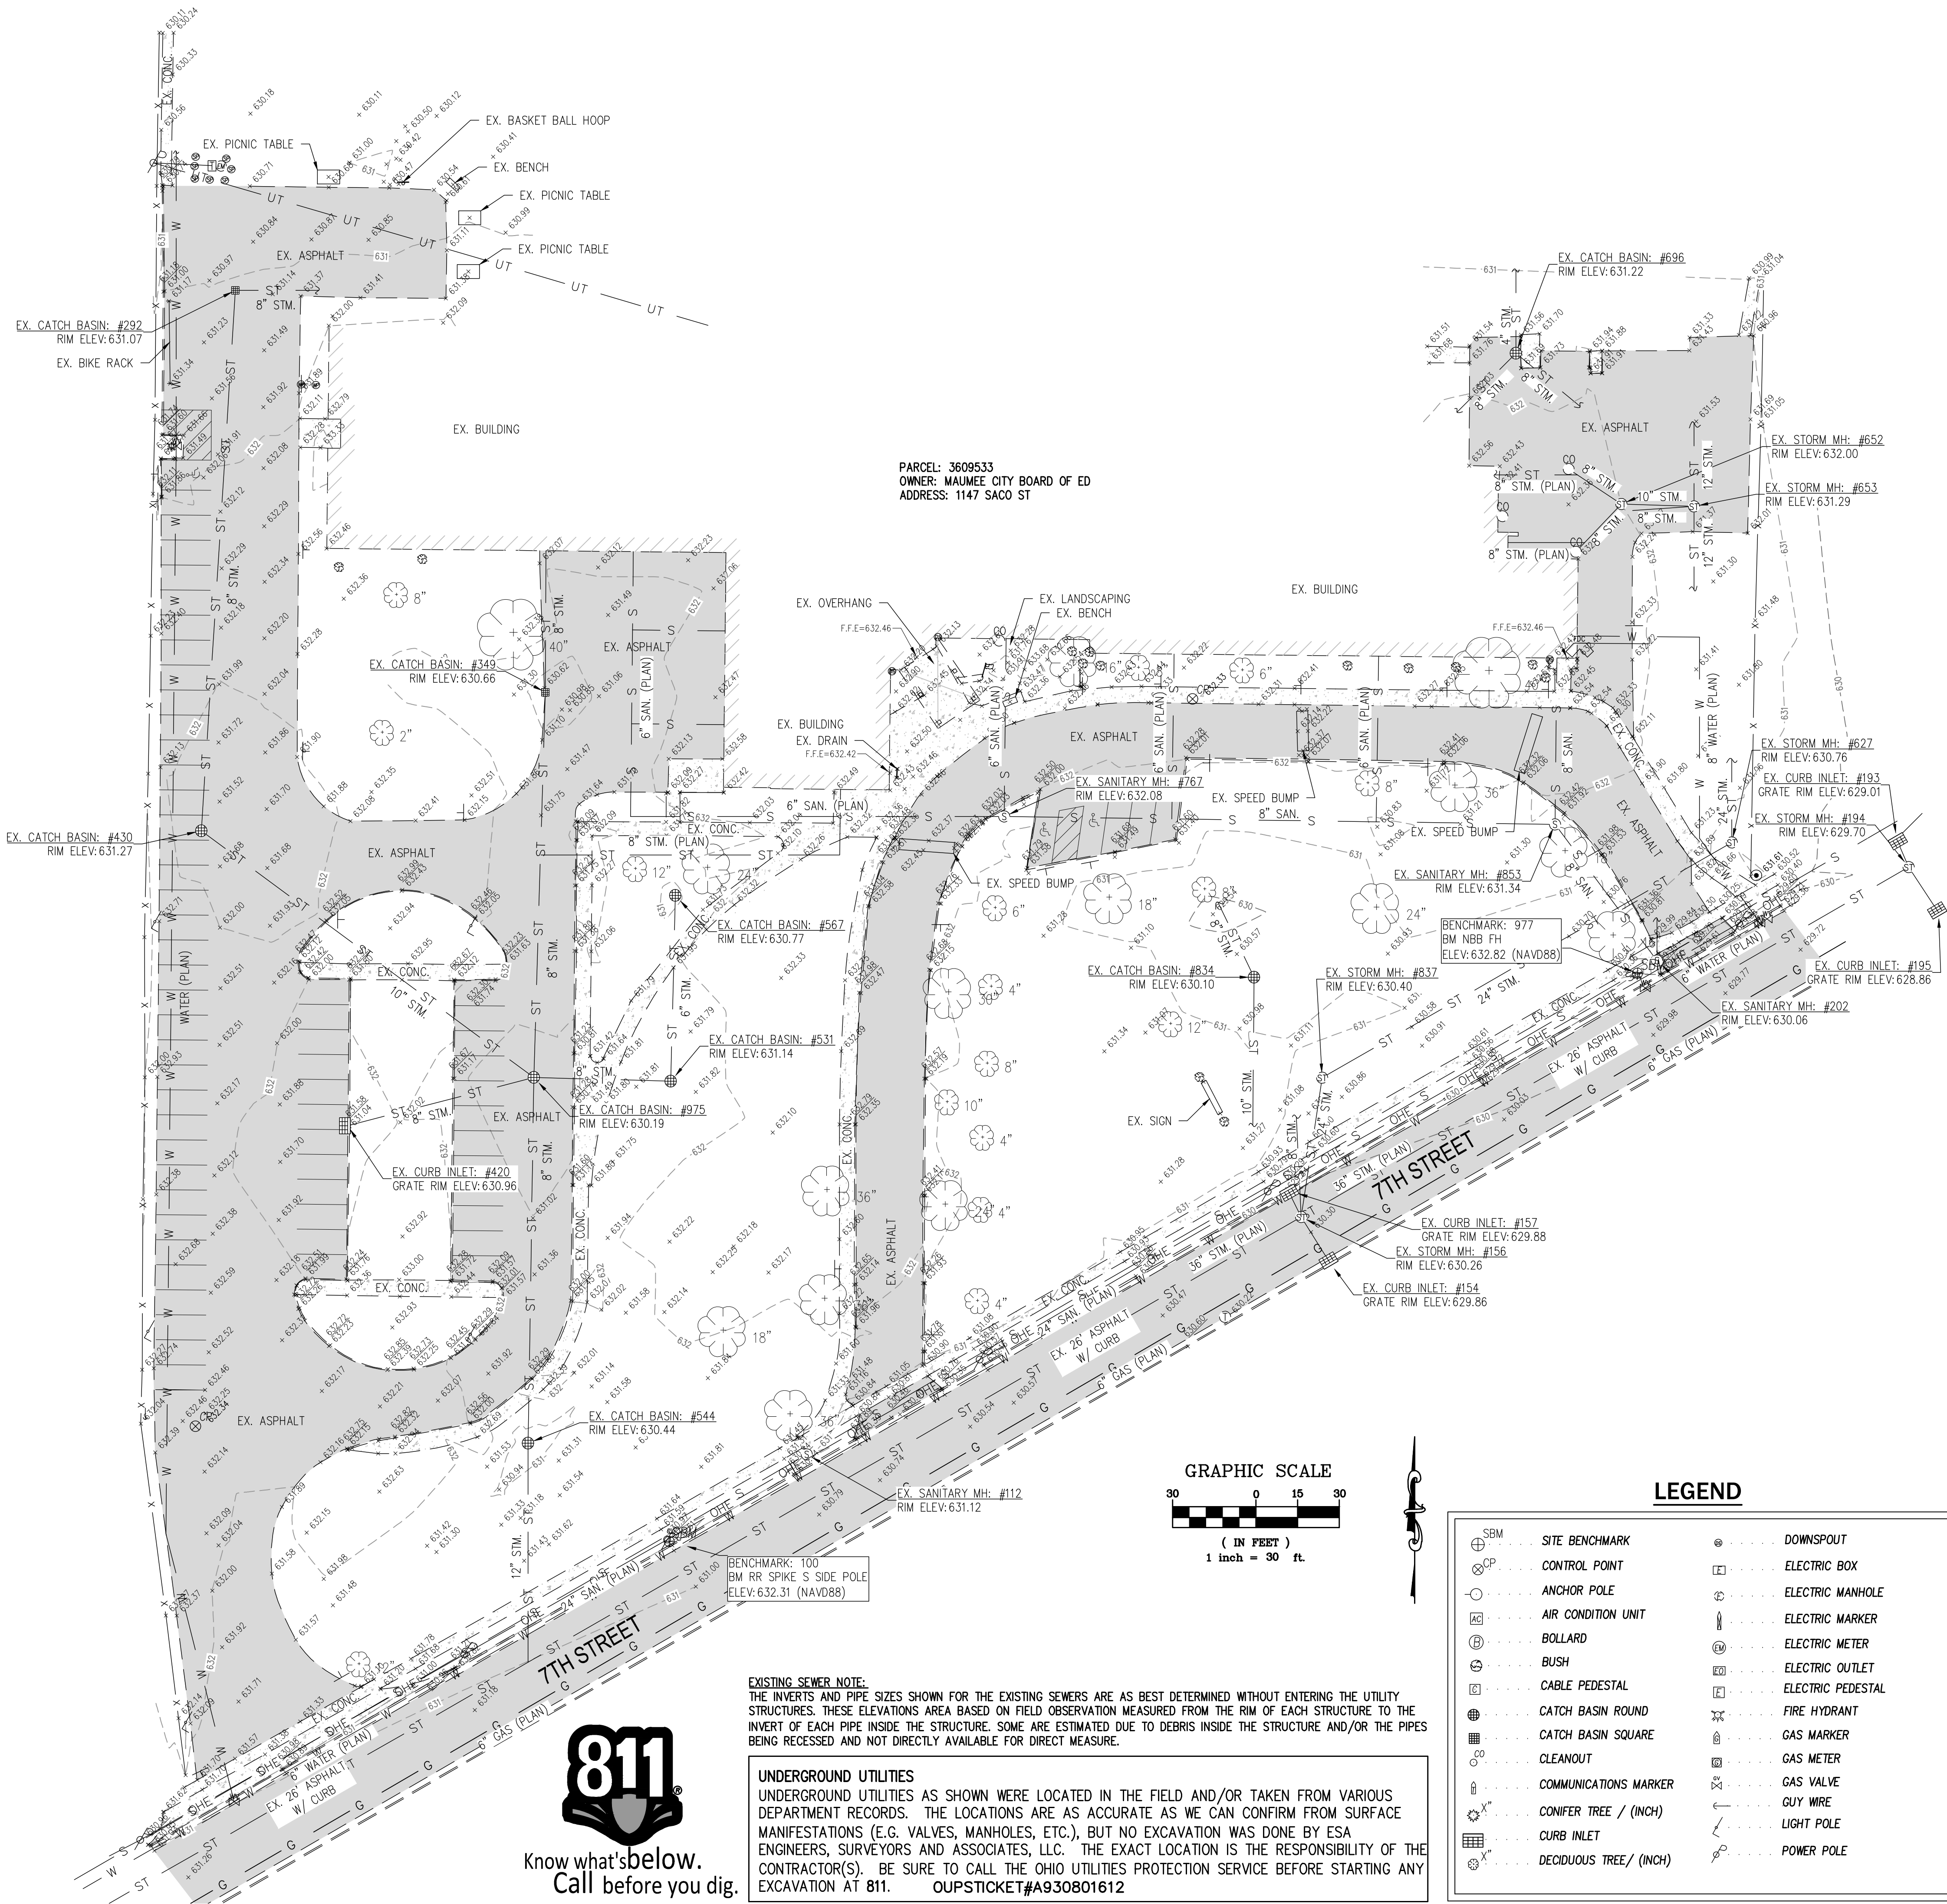- | | | | |
|---------------------------|---------------------|------------------------|----------------------------------|
| ⊕ SITE BENCHMARK | ⊙ DOWNSPOUT | ⊗ POST INDICATOR VALVE | ⊕ EXISTING SPOT ELEVATION |
| ⊙ CONTROL POINT | ⊠ ELECTRIC BOX | ⊙ SANITARY MANHOLE | ⊕ EXISTING TOP/CURB TOP/PVMT. |
| ⊙ ANCHOR POLE | ⊙ ELECTRIC MANHOLE | ⊙ SIGN | --- XXX --- EXISTING CONTOUR</td |
| ⊙ AIR CONDITION UNIT | ⊙ ELECTRIC MARKER | ⊙ STEEL POST | --- UE --- UNDERGROUND ELECTRIC |
| ⊙ BOLLARD | ⊙ ELECTRIC METER | ⊙ STORM MANHOLE | --- UC --- UNDERGROUND CABLE |
| ⊙ BUSH | ⊙ ELECTRIC OUTLET | ⊙ TRANSFORMER | --- x --- FENCE LINE |
| ⊙ CABLE PEDESTAL | ⊙ ELECTRIC PEDESTAL | ⊙ TELEPHONE MANHOLE | --- S --- SANITARY SEWER LINE |
| ⊙ CATCH BASIN ROUND | ⊙ FIRE HYDRANT | ⊙ TELEPHONE PEDESTAL | --- ST --- STORM SEWER LINE |
| ⊙ CATCH BASIN SQUARE | ⊙ GAS MARKER | ⊙ WATER MANHOLE | --- G --- GAS LINE |
| ⊙ CLEANOUT | ⊙ GAS METER | ⊙ WATER METER | --- W --- WATER LINE |
| ⊙ COMMUNICATIONS MARKER | ⊙ GAS VALVE | ⊙ WATER VALVE | --- OHE --- OVERHEAD UTILITIES |
| ⊙ CONIFER TREE / (INCH) | ⊙ GUY WIRE | ⊙ WOOD POST | --- UT --- UNDERGROUND TELEPHONE |
| ⊙ CURB INLET | ⊙ LIGHT POLE | | |
| ⊙ DECIDUOUS TREE / (INCH) | ⊙ POWER POLE | | |

EXISTING UTILITY STRUCTURE SCHEDULE

STRUCTURE TYPE	ID	RIM	PIPE SIZE	PIPE MATERIAL	DIRECTION	INVERT
EX. SANITARY MANHOLE	112	631.12	24"	RCP	E	609.92
		631.12	24"	RCP	W	609.92
EX. STORM MANHOLE	156	630.26	10"	PVC	N	626.86
(INVERTS PER PLAN)		630.26	8"	VIT	NE	624.46
		630.26	24"	RCP	NE	617.46
		630.26	36"	RCP	E	617.21
		630.26	12"	RCP	S	626.56
		630.26	36"	RCP	W	617.21
EX. CATCH BASIN	157	629.88	10"	VIT	S	626.98
EX. CATCH BASIN	193	629.01	4"	PVC	NE	626.86
		629.01	12"	RCP	S	624.91
EX. SANITARY MANHOLE	202	630.06	8"	UNKNOWN	N	617.56
(N & NE INVERTS PER PLAN)		630.06	8"	PVC	N	611.86
		630.06	8"	UNKNOWN	NE	612.96
		630.06	24"	RCP	E	609.66
		630.06	24"	RCP	W	609.66
EX. CATCH BASIN	292	631.07	8"	PVC	E	628.10
		631.07	8"	PVC	S	628.14
EX. CATCH BASIN	349	630.66	8"	PVC	N	625.51
		630.66	8"	VIT	S	625.51
EX. CATCH BASIN	420	630.96	8"	PVC	NE	625.61
EX. CATCH BASIN	430	631.27	8"	PVC	N	627.32
		631.27	10"	PVC	SE	627.27
EX. CATCH BASIN	531	631.14	6"	PVC	N	626.79
		631.14	8"	PVC	W	626.57
EX. CATCH BASIN	544	630.44	8"	VIT	N	624.19
		630.44	12"	VIT	S	623.99
EX. CATCH BASIN	567	630.77	6"	PVC	S	626.92
EX. STORM MANHOLE	627	630.76	24"	RCP	N	619.36
		630.76	30"	RCP	SW	619.21
EX. STORM MANHOLE	652	632.00	10"	PVC	E	629.00
		632.00	8"	PVC	SW	629.10
		632.00	8"	PVC	NW	629.00
EX. SANITARY MANHOLE	653	631.29	12"	VIT	N	621.24
		631.29	12"	VIT	S	621.79
		631.29	8"	VIT	W	622.09
		631.29	10"	PVC	W	628.84
EX. CATCH BASIN	696	631.22	4"	PVC	N	627.22
		631.22	8"	PVC	SE	622.57
		631.22	8"	PVC	SW	622.47
EX. SANITARY MANHOLE	767	632.08	6"	UNKNOWN	N	622.48
(SIZE PER PLAN)		632.08	6"	UNKNOWN	E	621.86
		632.08	6"	UNKNOWN	W	621.86
EX. CATCH BASIN	834	630.10	8"	PVC	NW	625.10
		630.10	10"	VIT	SW	624.80
EX. STORM MANHOLE	837	630.40	24"	RCP	E	618.50
		630.40	24"	RCP	SW	617.95
EX. SANITARY MANHOLE	853	631.34	8"	VIT	N	620.74
		631.34	8"	VIT	SE	620.14
		631.34	8"	VIT	NW	620.29
EX. CATCH BASIN	975	630.19	8"	VIT	N	625.09
		630.19	8"	PVC	E	627.09
		630.19	8"	VIT	S	624.84
		630.19	8"	PVC	W	625.34




8 North St. Clair - Toledo, Ohio 43604-1028
T 419.243.2400
www.thomasporterarchitects.com

CONSULTANTS:

ESA
Engineers, Surveyors & Associates, LLC
13355 Secor Rd., Toledo, Ohio, 43623 Phone (419) 475-9445

SEAL:

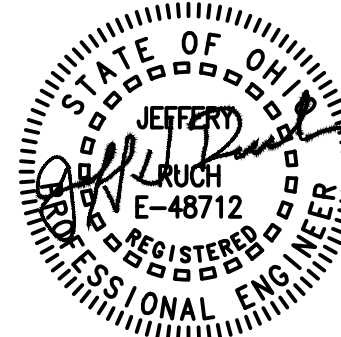

NOT FOR CONSTRUCTION UNLESS SIGNED & SEALED

SUMMER PAVING PROJECTS MAUMEE CITY SCHOOLS

WAYNE TRAIL ELEMENTARY
1147 7TH STREET
MAUMEE, OHIO 43537

FAIRFIELD ELEMENTARY
1313 EASTFIELD ROAD
MAUMEE, OHIO 43537

PROJECT TITLE:

ISSUE OR REVISION:

3.05.2020	BID DOCUMENTS
2.21.2020	90% SUBMITTAL

DATE: ISSUE / REVISION

DESIGNED: RGS,JHR

DRAWN: RGS

CHECKED: INITIALS

TPA COMMISSION NUMBER: 19060

DRAWING TITLE:

WAYNE TRAIL ELEMENTARY TOPO SURVEY

DRAWING NUMBER:

C0.1

SITE DEMOLITION LEGEND:

ITEM OR AREA TO BE REMOVED AS SHOWN AND NOTED.

DASHED HATCHING INDICATES AREAS OF SITE TO BE REMOVED AS SHOWN AND NOTED.

INDICATES HARD SURFACE ASPHALT REMOVAL
INDICATES HARD SURFACE CONCRETE REMOVAL
INDICATES SOFT SURFACE REMOVAL (GRASS, GRAVEL, SOILS)

PHOTO LOCATION TAG

SITE DEMO KEY NOTE

EXISTING BUILDING DOWNSPOUTS TO REMAIN. TYPICAL. PROTECT DURING CONSTRUCTION

EXISTING BENCH OR PICNIC TABLE TO REMAIN. TYPICAL. PROTECT DURING CONSTRUCTION

EXISTING POST MOUNTED SITE SIGNAGE. SEE SITE PLAN FOR SIGNS TO BE REMOVED, RELOCATED, OR TO REMAIN.

GENERAL SITE DEMOLITION NOTES:

- THE STRUCTURAL INTEGRITY OF THE BUILDINGS SHALL BE MAINTAINED DURING THE ENTIRE PROJECT. PROVIDE ANY & ALL SHORING AS REQUIRED.
- THE SITE SHALL BE KEPT TIDY AND CLEAR OF MISCELLANEOUS CONSTRUCTION DEBRIS AT THE END OF EACH WORKING DAY. THE SITE SHALL BE CLEARED OF ALL DEBRIS AT THE COMPLETION OF THE PROJECT.
- GRADE ALL DISTURBED SITE AREAS AT THE COMPLETION OF THE PROJECT.
- EACH CONTRACTOR SHALL NOTIFY THE OWNER'S REPRESENTATIVE AND ARCHITECT IMMEDIATELY IF A DISCREPANCY IS FOUND BETWEEN THE DIMENSIONS GIVEN AND THE ACTUAL DIMENSIONS IN THE FIELD. CONTRACTOR IS TO FIELD VERIFY ALL DIMENSIONS PRIOR TO WORK AND ORDERING OF MATERIALS.
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- ALL DEMOLITION MATERIAL TO BE DISPOSED OF LEGALLY. OFF SITE, UNLESS SPECIFICALLY NOTED OTHERWISE.

SITE DEMOLITION KEYED NOTES:

SEE SHEET D1.1 FOR KEYED NOTES ON FAIRFIELD

SEE SHEET D2.1 FOR KEYED NOTES ON WAYNE TRAIL

DEMOLITION SITE PLAN - FAIRFIELD ELEMENTARY

SCALE: 1/2"=1'-0"


THOMAS
PORTER
ARCHITECTS

8 North St. Clair - Toledo, Ohio 43604-1028
T 419.243.2400
www.thomasporterarchitects.com

CONSULTANTS:

esa
Engineers, Surveyors & Associates, LLC
5353 Secor Rd., Toledo, Ohio 43623 Phone (419) 475-9445

SEAL:

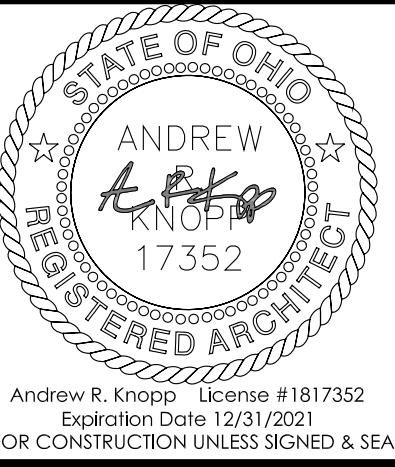

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Expiration Date 12/31/2021
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MAUMEE CITY SCHOOLS

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MAUMEE, OHIO 43537

FAIRFIELD ELEMENTARY
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MAUMEE, OHIO 43537

PROJECT TITLE:

ISSUE OR REVISION:

03.05.2020 BID DOCUMENTS

DATE ISSUE / REVISION

DESIGNED: ACH

DRAWN: ACH

CHECKED: JEA


TPA COMMISSION NUMBER: 19060

DRAWING TITLE:

FAIRFIELD
EXIST. CONDITIONS
/DEMO SITE PLAN

DRAWING NUMBER:

D1.0

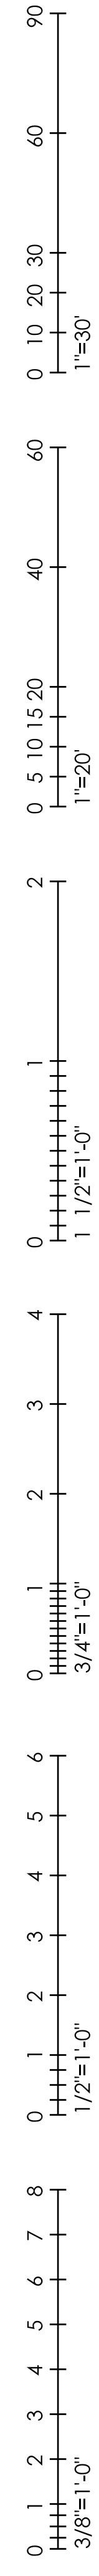

1 EXISTING PHOTO
D1.1 NOT TO SCALE



2 EXISTING PHOTO
D1.1 NOT TO SCALE



3 EXISTING PHOTO
D1.1 NOT TO SCALE



4 REFERENCE PHOTO
D1.1 NOT TO SCALE



5 EXISTING PHOTO
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6 EXISTING PHOTO
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7 EXISTING PHOTO
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8 REFERENCE PHOTO
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11 EXISTING PHOTO
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12 REFERENCE PHOTO
D1.1 NOT TO SCALE



13 EXISTING PHOTO
D1.1 NOT TO SCALE



14 EXISTING PHOTO
D1.1 NOT TO SCALE



15 EXISTING PHOTO
D1.1 NOT TO SCALE



16 REFERENCE PHOTO
D1.1 NOT TO SCALE

FAIRFIELD ELEMENTARY SITE DEMOLITION KEYED NOTES:

- SD1 REMOVE EXISTING ±6" OF ASPHALT AND STONE BASE IN ITS ENTIRETY AND STOCKPILE. ENSURE STOCKPILED MATERIAL IS CLEAN AND FREE OF DIRT. REMOVE ±8" OF DIRT AND DISPOSE. PREPARE FOR STONE BASE AND ASPHALT AS DETAILED ON SHEET A3.0. NEW PAVING TO BE HEAVY DUTY. SEE GRADING PLAN
- SD2 EXISTING PLAYGROUND EQUIPMENT, BUILDING EQUIPMENT, BENCHES, FENCING, SIGNAGE, TREE, SHRUB, ETC. AS SHOWN TO REMAIN. PROTECT DURING CONSTRUCTION. COORDINATE WITH OWNER IF WORK REQUIRES TEMPORARY RELOCATION OF ITEM OR ITEMS.
- SD3 EXISTING CONCRETE SLAB TO REMAIN. PROTECT DURING CONSTRUCTION.
- SD4 REMOVE EXISTING CONCRETE SLAB IN ITS ENTIRETY. DISPOSE OFF SITE. PROTECT ADJACENT SURFACES TO REMAIN. REMOVE SLAB UP TO EXISTING UNEVEN CONTROL JOINTS OR SAW CUT IF NECESSARY. PREPARE FOR NEW SURFACE AS SHOWN ON SITE PLAN.
- SD5 REMOVE EXISTING CONCRETE CURB IN ITS ENTIRETY. PROTECT ADJACENT CURBS ALONG STREET THAT ARE TO REMAIN. REMOVE CURB UP TO EXISTING CONTROL JOINTS OR SAW CUT IF NECESSARY. PREPARE FOR REPLACEMENT OR NEW SURFACE AS SHOWN ON SITE PLAN.
- SD6 REMOVE EXISTING ASPHALT SPEED BUMP IN ITS ENTIRETY.
- SD7 REMOVE EXISTING TREE OR SHRUB IN ITS ENTIRETY INCLUDING STUMP AND ROOT SYSTEM.
- SD8 REMOVE EXISTING CATCH BASIN. PREPARE FOR REPLACEMENT OR PERMANENT REMOVAL. SEE SITE UTILITY PLAN FOR COMPLETE SCOPE OF WORK.
- SD9 REMOVE EXISTING ±6" OF ASPHALT AND STONE BASE IN ITS ENTIRETY AND STOCKPILE. ENSURE STOCKPILED MATERIAL IS CLEAN AND FREE OF DIRT. REMOVE ±5 1/2" OF DIRT AND DISPOSE. PREPARE FOR STONE BASE AND ASPHALT AS DETAILED ON SHEET A3.0. SEE GRADING PLAN. NEW PAVING TO BE STANDARD DUTY
- SD10 CAP EXISTING ELECTRICAL WIRE FEEDING EXISTING LIGHT. REMOVE EXISTING LIGHT POST AND CONCRETE BASE IN ITS ENTIRETY. PREPARE FOR ELECTRICAL WIRE EXTENSION AND JUNCTION BOX INSTALLATION AS SHOWN ON SITE PLAN.
- SD11 RELOCATE EXISTING CONCRETE PARKING BUMPERS DURING CONSTRUCTION. REPOSITION ON NEW ASPHALT AS SHOWN ON SITE PLAN.
- SD12 CAREFULLY REMOVE EXISTING SIGN AND POLE/CONCRETE BASE AND RETAIN SIGN/POLE. COORDINATE REINSTALLATION WITH OWNER AS SHOWN ON SITE PLAN.
- SD13 REMOVE EXISTING STEEL/WOOD POSTS AND SWING GATES IN THEIR ENTIRETY INCLUDING ANY CONCRETE BASES. RETAIN SWINGING GATES FOR OWNER.
- SD14 REMOVE EXISTING WOOD POST FENCING IN ITS ENTIRETY AND DISPOSE.
- SD15 REMOVE EXISTING STEEL/WOOD POSTS IN THEIR ENTIRETY INCLUDING CONCRETE BASE. PREPARE FOR NEW BOLLARDS AND CHAIN.

THOMAS
PORTER
ARCHITECTS

8 North St. Clair - Toledo, Ohio 43604-1028
T 419.243.2400
www.thomasporterarchitects.com

CONSULTANTS:

esa

Engineers, Surveyors & Associates, LLC
5353 Secor Rd., Toledo, Ohio 43623 Phone (419) 475-9445

SEAL:



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MAUMEE CITY SCHOOLS

WAYNE TRAIL ELEMENTARY
1147 7TH STREET
MAUMEE, OHIO 43537

FAIRFIELD ELEMENTARY
1313 EASTFIELD ROAD
MAUMEE, OHIO 43537

PROJECT TITLE:

ISSUE OR REVISION:

03.05.2020 BID DOCUMENTS

DATE ISSUE / REVISION

DESIGNED: ACH

DRAWN: ACH

CHECKED: JEA

TPA COMMISSION NUMBER: 19060

DRAWING TITLE:



FAIRFIELD

EXIST. PHOTOS &

DEMO NOTES

DRAWING NUMBER:

D1.1

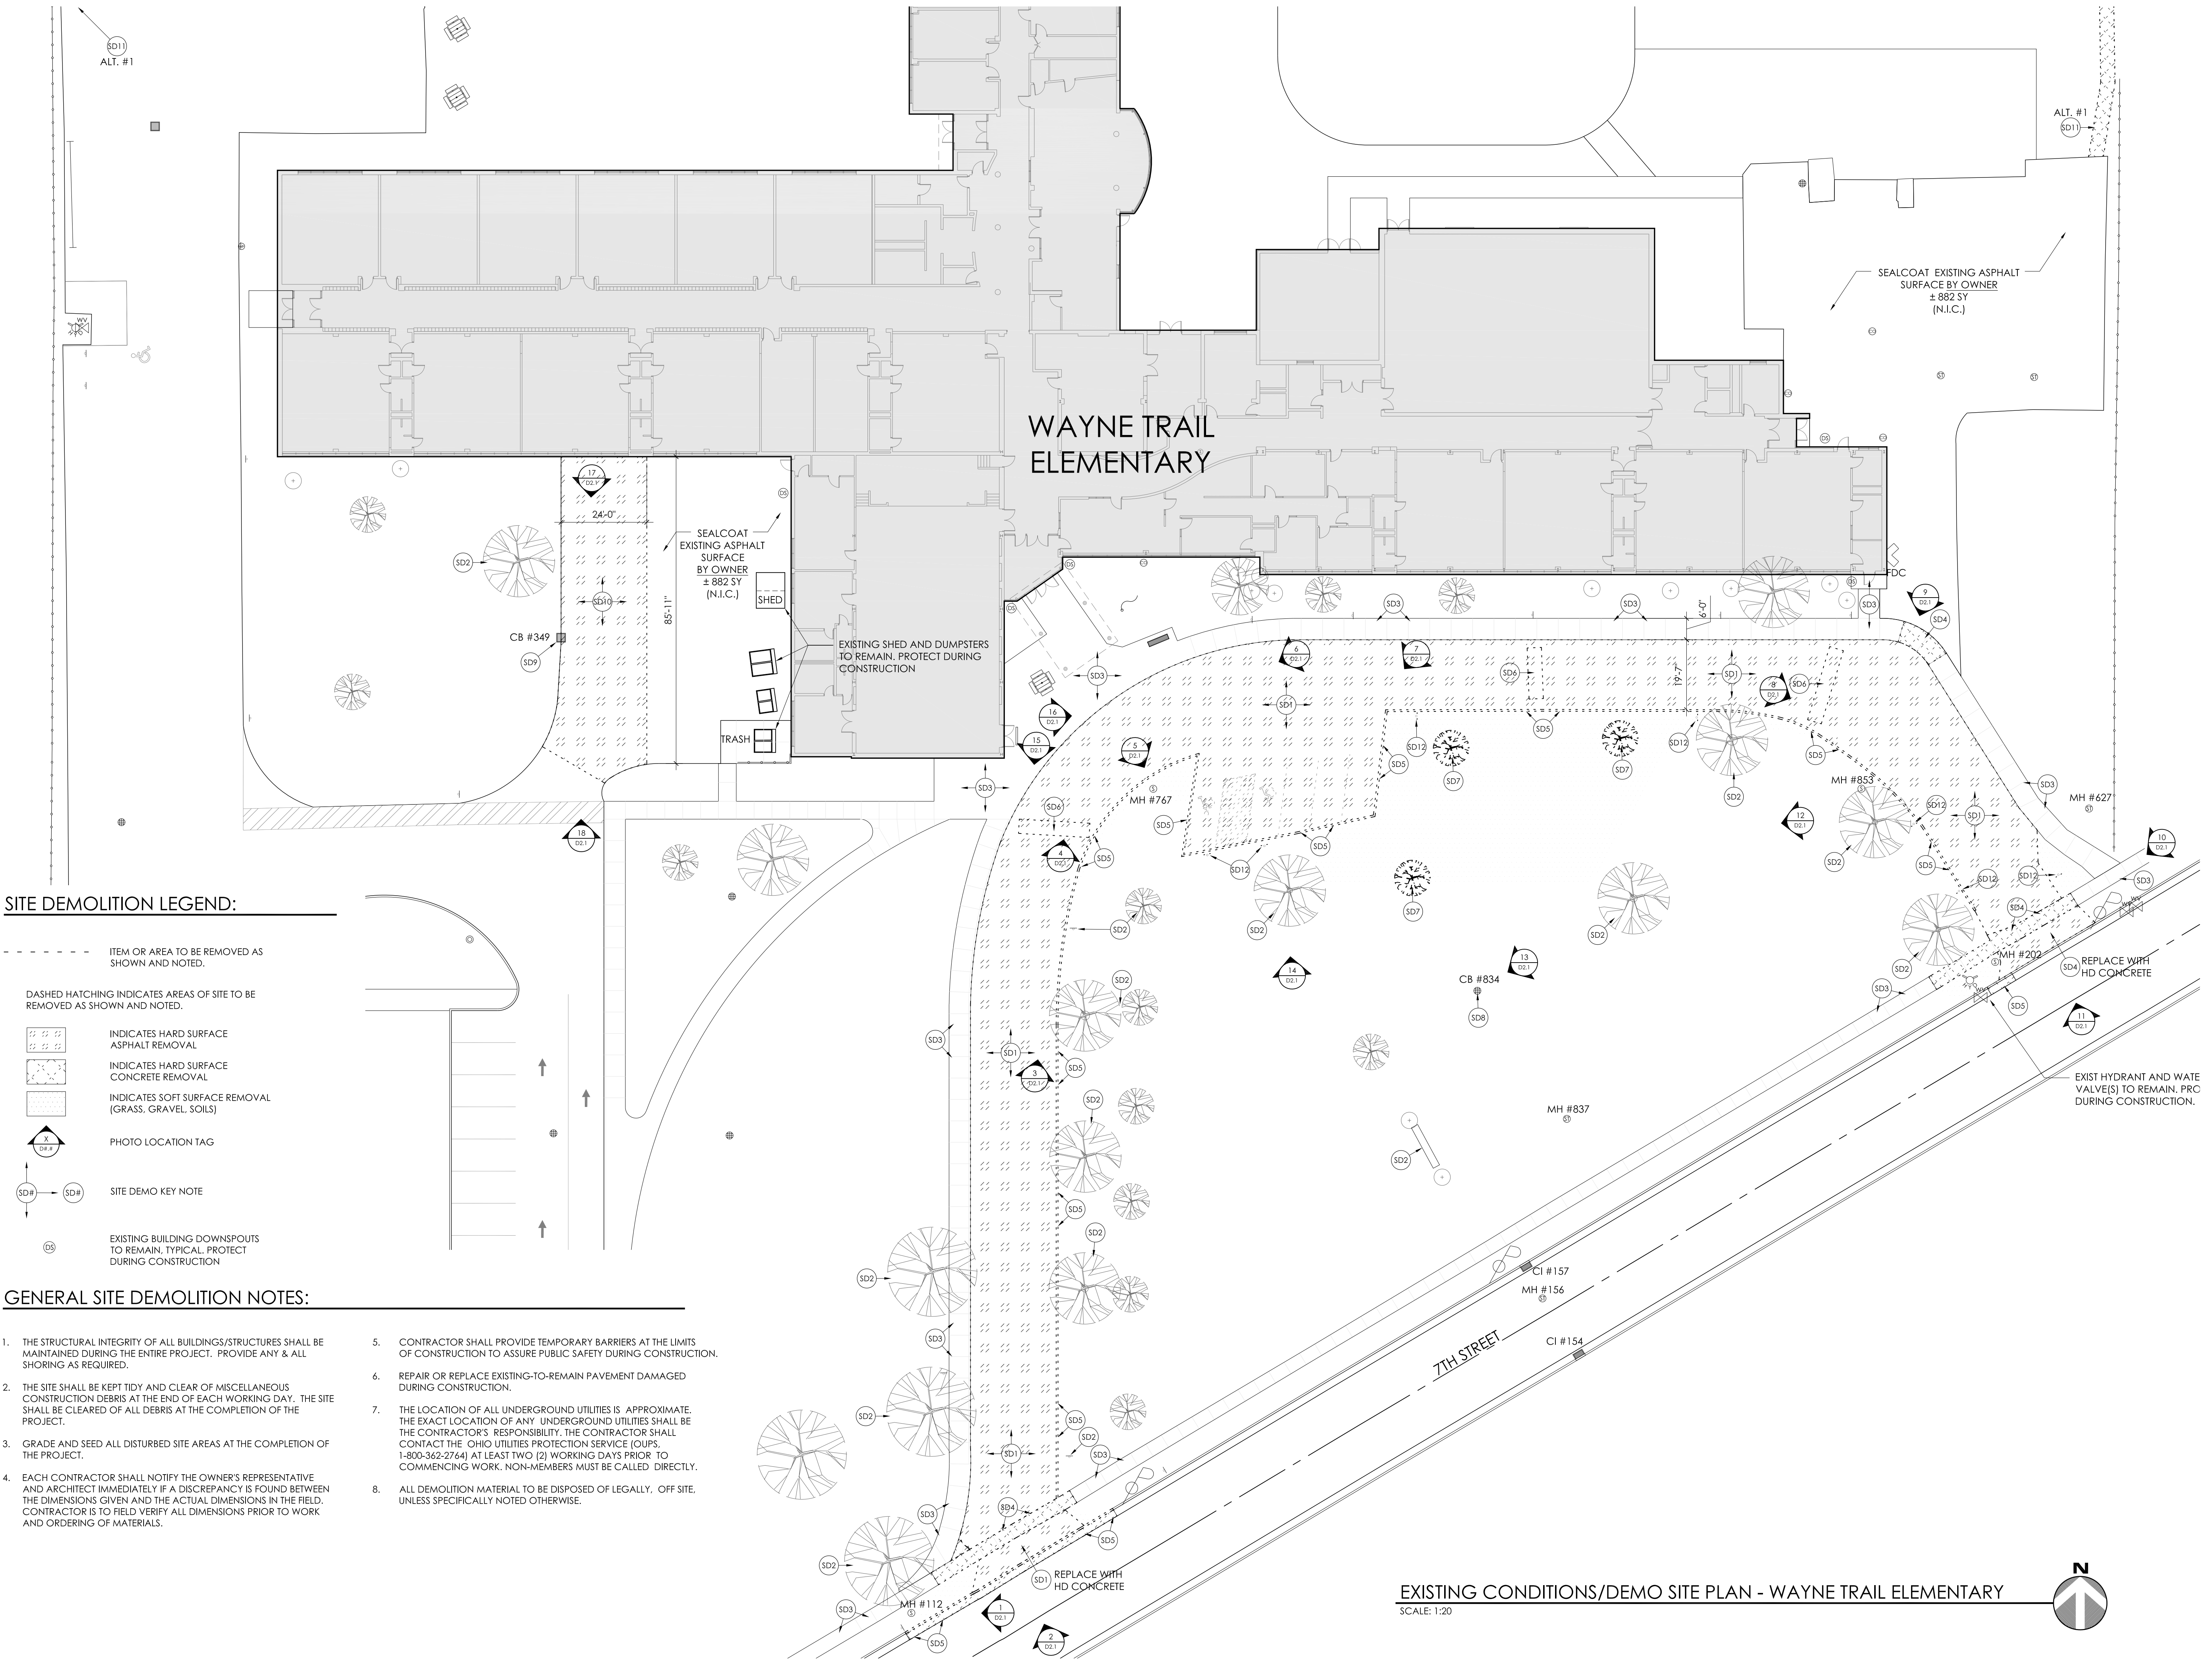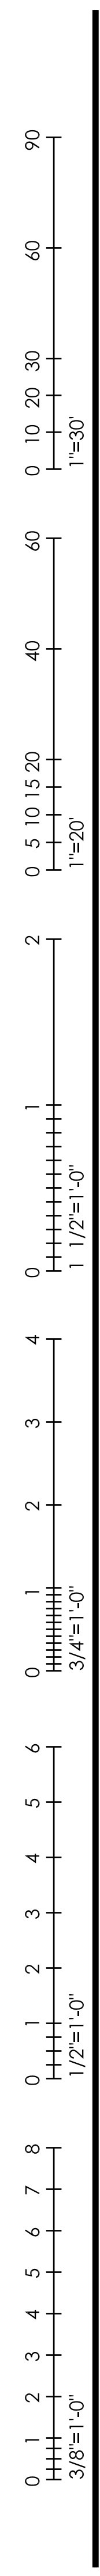

SITE DEMOLITION LEGEND:

- ITEM OR AREA TO BE REMOVED AS SHOWN AND NOTED.
- DASHED HATCHING INDICATES AREAS OF SITE TO BE REMOVED AS SHOWN AND NOTED.
- INDICATES HARD SURFACE ASPHALT REMOVAL
- INDICATES HARD SURFACE CONCRETE REMOVAL
- INDICATES SOFT SURFACE REMOVAL (GRASS, GRAVEL, SOILS)
- PHOTO LOCATION TAG
- SITE DEMO KEY NOTE
- EXISTING BUILDING DOWNSPOUTS TO REMAIN, TYPICAL, PROTECT DURING CONSTRUCTION

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PORTER
ARCHITECTS

8 North St. Clair - Toledo, Ohio 43604-1028
T 419.243.2400
www.thomasporterarchitects.com

CONSULTANTS:

esa

Engineers, Surveyors & Associates, LLC
5353 Secor Rd., Toledo, Ohio, 43623 Phone (419) 475-9445

SEAL:

STATE OF OHIO
ANDREW
KNOPP
17352
REGISTERED ARCHITECT

Andrew R. Knopp License #1817352
Expiration Date 12/31/2021
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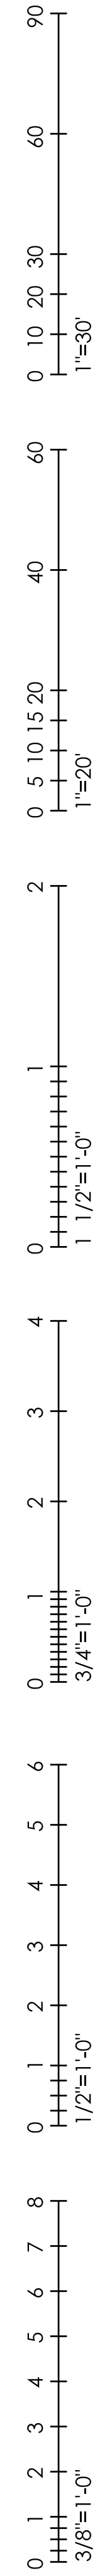
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MAUMEE, OHIO 43537

FAIRFIELD ELEMENTARY
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MAUMEE, OHIO 43537

PROJECT TITLE:

ISSUE OR REVISION:

03.05.2020	BID DOCUMENTS
DATE	ISSUE / REVISION
DESIGNED:	ACH
DRAWN:	ACH
CHECKED:	JEA
TPA COMMISSION NUMBER:	19060
DRAWING TITLE:	WAYNE TRAIL EXIST. CONDITIONS /DEMO SITE PLAN
DRAWING NUMBER:	D2.0



1
D2.1
EXISTING PHOTO
NOT TO SCALE



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D2.1
EXISTING PHOTO
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NOT TO SCALE



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REFERENCE PHOTO
NOT TO SCALE

WAYNE TRAIL ELEMENTARY SITE DEMOLITION KEYED NOTES:

- SD1 REMOVE EXISTING ±6" OF ASPHALT AND STONE BASE IN ITS ENTIRETY AND STOCKPILE. ENSURE STOCKPILED MATERIAL IS CLEAN AND FREE OF DIRT. REMOVE ±8" OF DIRT AND DISPOSE. PREPARE FOR STONE BASE AND ASPHALT AS DETAILED ON SHEET A3.0. NEW PAVING TO BE HEAVY DUTY. SEE GRADING PLAN
- SD2 EXISTING BUILDING EQUIPMENT, BENCHES, FENCING, SIGNAGE, TREE, SHRUB, ETC. AS SHOWN TO REMAIN. PROTECT DURING CONSTRUCTION. COORDINATE WITH OWNER IF WORK REQUIRES TEMPORARY RELOCATION OF ITEM OR ITEMS.
- SD3 EXISTING CONCRETE SLAB OR CURB TO REMAIN. PROTECT DURING CONSTRUCTION.
- SD4 REMOVE EXISTING CONCRETE SLAB IN ITS ENTIRETY. DISPOSE OFF SITE. PROTECT ADJACENT SURFACES TO REMAIN. REMOVE SLAB UP TO EXISTING UNEVEN CONTROL JOINTS OR SAW CUT IF NECESSARY. PREPARE FOR NEW SURFACE AS SHOWN ON SITE PLAN.
- SD5 REMOVE EXISTING CONCRETE CURB IN ITS ENTIRETY. PROTECT ADJACENT CURBS ALONG STREET THAT ARE TO REMAIN. REMOVE CURB UP TO EXISTING CONTROL JOINTS OR SAW CUT IF NECESSARY. PREPARE FOR REPLACEMENT OR NEW SURFACE AS SHOWN ON SITE PLAN.
- SD6 REMOVE EXISTING ASPHALT SPEED BUMP IN ITS ENTIRETY.
- SD7 REMOVE EXISTING TREE OR SHRUB IN ITS ENTIRETY INCLUDING STUMP AND ROOT SYSTEM.
- SD8 REMOVE EXISTING CATCH BASIN TO REMAIN. PREPARE FOR NEW INLET. SEE SITE UTILITY PLAN FOR COMPLETE SCOPE OF WORK.
- SD9 EXISTING CATCH BASIN TO REMAIN. CLEAN AND ENSURE BASIN IN KEPT CLEAR OF LEAVES AND ANY OTHER DEBRIS DURING CONSTRUCTION.
- SD10 MILL TOP 1 1/2" LAYER OF EXISTING ASPHALT SURFACE. PREPARE FOR NEW ASPHALT WEARING COURSE. SEE GRADING PLAN, SITE PLAN, AND DETAILS
- SD11 **ALTERNATE 1:** REMOVE EXISTING 4'-0" WIDE CONCRETE SIDEWALKS LEADING TO HIGH SCHOOL PROPERTY IN ITS ENTIRETY (APPROX 788 LF). PREPARE FOR NEW 5'-0" WIDE STANDARD DUTY CONCRETE SIDEWALK.
- SD12 CAREFULLY REMOVE EXISTING SIGN AND POLE/CONCRETE BASE AND RETAIN SIGN/POLE. COORDINATE REINSTALLATION WITH OWNER AS SHOWN ON SITE PLAN.
- SD13 NOT USED AT WAYNE TRAIL ELEMENTARY
- SD14 NOT USED AT WAYNE TRAIL ELEMENTARY
- SD15 NOT USED AT WAYNE TRAIL ELEMENTARY

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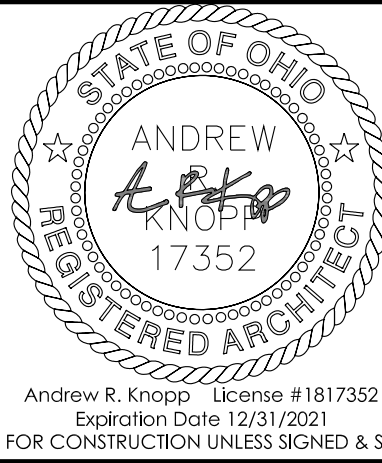
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PROJECT TITLE:

ISSUE OR REVISION:

03.05.2020 BID DOCUMENTS

DATE ISSUE / REVISION

DESIGNED: ACH

DRAWN: ACH

CHECKED: JEA

TPA COMMISSION NUMBER: 19060

DRAWING TITLE:

WAYNE TRAIL
EXIST. PHOTOS &
DEMO NOTES

DRAWING NUMBER:

D2.1

SITE PLAN LEGEND:

- NEW STANDARD DUTY CONCRETE SURFACE.
STANDARD DUTY DETAIL 3/A3.0
- NEW HEAVY DUTY CONCRETE SURFACE.
HEAVY DUTY DETAIL 3/A3.0
- NEW STANDARD DUTY ASPHALT SURFACE.
DETAIL 1/A3.0
- NEW HEAVY DUTY ASPHALT SURFACE.
DETAIL 2/A3.0
- EXISTING BUILDING FOOTPRINT
- GRADE AND SEED DISTURBED AREAS OF SITE.
TYPICAL THROUGHOUT OVERALL SITE AND
ENTIRE PROJECT.
- RE-MULCH DISTURBED AREAS OF PLAYGROUND
- MILL AND RESURFACE TOP ±1 1/2" EXISTING
ASPHALT WEARING COURSE
- EXISTING CHAIN LINK OR SPLIT RAIL
FENCING/GATES TO REMAIN.
- NEW OR EXISTING SITE SIGNAGE AS
NOTED AND SPECIFIED.
- PROPOSED BOLLARD, TYPE AS NOTED.
SEE DETAILS SHEET A3.0
- TYPICAL TRAFFIC CONTROL PAVEMENT
MARKING. COLOR TO BE WHITE U.N.O.
- CONTROL JOINT
CONCRETE PAVEMENT
CONTROL/EXPANSION JOINT
MARKINGS.
- EXPANSION JOINT
INTEGRAL OR STANDALONE 6" CONCRETE CURB
- EXISTING DECIDUOUS OR CONIFEROUS
TREE OR SHRUB TO REMAIN U.N.O.
- NEW DECIDUOUS TREE
- EXISTING BENCH OR TABLE TO REMAIN
- SITE DIRECTIONAL SIGNAGE. SEE
DETAIL 6/A3.2
- EXISTING FLAG POLE TO REMAIN
- PROPERTY LINES. SEE CIVIL DRAWINGS
- SIGNAGE TAG. SEE 3/A3.2

KEYED SITE PLAN NOTES

- RELOCATED CONCRETE WHEEL STOP (TYP. OF 12).
SEE DETAIL 8/A3.0 AND 9/A3.0.
- NEW DECIDUOUS TREE BY CONTRACTOR. COORDINATE
SPECIES WITH OWNER/ARCHITECT. SEE DETAIL 5/A3.2
- NEW ASPHALT SPEED BUMP. SEE DETAIL 10/A3.0
- EASE ±2' 0" SECTION OF NEW CONCRETE CURB DOWN
FLUSH TO NEW ASPHALT TO SERVE AS PARKING LOT
OVERFLOW. GRADE AND SEED AS REQUIRED.
- EXTEND WIRE FEED AND CONDUIT TO LAWN AREA FOR
FUTURE LIGHT. CONDUIT SHALL BE PVC SCHEDULE 80. MIN
1" Ø INSTALLED 36" BELOW GRADE. WIRE SHALL BE MIN #12
COPPER. ENSURE WATER TIGHT CONDUIT CONNECTORS
AND CAPS.
- NEW BOLLARD, TYPE A. SEE DETAIL 1/A3.2
- NEW BOLLARD, TYPE B. SEE DETAIL 2/A3.2
- NEW 2' 0" X 4' 0" DETECTABLE WARNING STRIP.
COORDINATE INSTALLATION PRIOR TO CONCRETE POUR

SPECIAL NOTE:
CONTRACTOR TO PROVIDE FOR 2,500 TON
#304 VIRGIN AGGREGATE IN BASE BID ITEM 1.0.
REFERENCE SPECIFICATION SECTION 01010,
SUMMARY OF WORK.

OVERALL FAIRFIELD SITE PLAN

1" = 20'

CONSULTANTS:

esa

Engineers, Surveyors & Associates, LLC
5353 Secor Rd., Toledo, Ohio 43623 Phone (419) 475-9445

SEAL:



SUMMER PAVING PROJECTS
MAUMEE CITY SCHOOLS

WAYNE TRAIL ELEMENTARY
1147 7TH STREET
MAUMEE, OHIO 43537

FAIRFIELD ELEMENTARY
1313 EASTFIELD ROAD
MAUMEE, OHIO 43537

PROJECT TITLE:

ISSUE OR REVISION:

03.05.2020 BID DOCUMENTS

DATE ISSUE / REVISION

DESIGNED: ACH

DRAWN: ACH

CHECKED: JEA

TPA COMMISSION NUMBER: 19060

DRAWING TITLE:

FAIRFIELD
ELEMENTARY
SITE PLAN

DRAWING NUMBER:

A1.0

90
60
30
0 10 20 30
1"=30'
40
0 5 10 15 20
1"=20'
2
0 5 10 15 20
1"=20'
1
0 1 2 3 4 5 6
1 1/2"=1'-0"
2
0 1 2 3 4 5 6
3/4"=1'-0"
1
0 1 2 3 4 5 6
3/4"=1'-0"
2
0 1 2 3 4 5 6
3/4"=1'-0"
1
0 1 2 3 4 5 6
3/4"=1'-0"
2
0 1 2 3 4 5 6
3/4"=1'-0"
1
0 1 2 3 4 5 6
3/4"=1'-0"

PARCEL: 3600194
OWNER: CITY OF MAUMEE
ADDRESS: 3215 EASTFIELD DR

PARCEL: 3600191
OWNER: MAUMEE CITY BOARD OF ED
ADDRESS: 3213 EASTFIELD DR

REPLACE ASPHALT PATH TO CASS
ROAD INCLUDING ACCESS TO
CUL-DE-SAC. SEE PHOTOS 17/D1.1
AND 18/D1.1. PATH IS APPROX.
866 LF BY 8' WIDE. MATCH EX.
SLOPES AND ELEVATIONS.

EX. STORM MH: #977
RIM ELEV: 631.63

PARCEL: 3672795
OWNER: TRANS CON
BUILDERS INC

EX. SANITARY MH: #724
RIM ELEV: 631.69

EX. STORM MH: #718
RIM ELEV: 632.44

EX. STORM MH: #841
RIM ELEV: 632.36

EX. STORM MH: #459
RIM ELEV: 632.21

EX. STORM MH: #486
RIM ELEV: 632.72

EX. STORM MH: #133
RIM ELEV: 632.06

EX. STORM MH: #137
RIM ELEV: 631.61

LEGEND

	AIR CONDITION UNIT		GAS VALVE		EXISTING SPOT ELEVATION
	BUSH		GUY WIRE		EXISTING TOP/CURB TOP/P.V.M.T.
	CATCH BASIN ROUND		IRON PIN FOUND		EXISTING CONTOUR
	CATCH BASIN SQUARE		LIGHT POLE		UNDERGROUND ELECTRIC
	CLEANOUT		POWER POLE		UNDERGROUND CABLE
	CONIFER TREE / (INCH)		SANITARY MANHOLE		FENCE LINE
	CONTROL POINT		SIGN		SANITARY SEWER LINE
	CURB INLET		SITE BENCHMARK		STORM SEWER LINE
	DECIDUOUS TREE / (INCH)		STEEL POST		GAS LINE
	DOWNSPOUT		STORM MANHOLE		WATER LINE
	ELECTRIC BOX		TRANSFORMER		OVERHEAD UTIL. WIRES
	ELECTRIC METER		TELEPHONE PEDESTAL		UNDERGROUND TELEPHONE
	ELECTRIC PEDESTAL		WATER MANHOLE		
	FIRE HYDRANT		WATER METER		
	FLAG POLE		WATER VALVE		
	GAS METER		WOOD POST		

EXISTING UTILITY STRUCTURE SCHEDULE						EXISTING UTILITY STRUCTURE SCHEDULE					
STRUCTURE TYPE	ID	RIM	PIPE SIZE	PIPE MAT'L	DIRECTION	INVERT	STRUCTURE TYPE	ID	RIM	PIPE SIZE	PIPE MAT'L
EX. SAN. MANHOLE	133	632.06	10"	UNKNOWN	W	623.51	EX. SAN. MANHOLE	724	631.69	30"	RCP
			10"	UNKNOWN	E	623.46				36"	RCP
EX. CURB INLET	137	631.61	4"	PVC	SW	629.81	EX. STORM MANHOLE	841	632.36	15"	RCP
			BOTTOM			629.56				12"	PVC
EX. CATCH BASIN	160		6"	VIT	N	627.87				15"	RCP
			6"	VIT	S	627.87	EX. CATCH BASIN	929	631.79	6"	VIT
EX. CATCH BASIN	343	631.18	4"	PVC	NW	629.68	(TO BE REMOVED)	977	631.63	36"	RCP
(TO BE REMOVED)			6"	VIT	S	628.48	EX. STORM MANHOLE	1038	631.00	4"	PVC
EX. CATCH BASIN	438	631.09	4"	CPP	SW	629.54				6"	PVC
(TO BE REMOVED)			6"	VIT	N	627.59	EX. CATCH BASIN	1038	631.00	4"	PVC
AND REPLACED)			6"	VIT	NE	627.79				6"	PVC
			10"	UNKNOWN	SW	627.59	EX. CATCH BASIN	2000	631.12	8"	PVC
EX. STORM MANHOLE	459	632.21	12"	RCP	N	626.46				10"	PVC
			15"	RCP	W	626.31				6"	PVC
EX. SAN. MANHOLE	486	632.72	FILLED WITH WATER	BOTTOM:	625.22					12"	PVC
EX. STORM MANHOLE	718	632.44		UNKNOWN	SE	622.29					
				UNKNOWN	NW	622.24					
			15"	UNKNOWN	E	624.04					

EXISTING SEWER NOTE:
THE INVERTS AND PIPE SIZES SHOWN FOR THE EXISTING SEWERS ARE AS
BEST DETERMINED WITHOUT ENTERING THE UTILITY STRUCTURES. THESE
ELEVATIONS ARE BASED ON FIELD OBSERVATION MEASURED FROM THE RIM
OF EACH STRUCTURE TO THE INVERT OF EACH PIPE INSIDE THE STRUCTURE.
SOME ARE ESTIMATED DUE TO DEBRIS INSIDE THE STRUCTURE AND/OR THE
PIPES BEING RECESSED AND NOT DIRECTLY AVAILABLE FOR DIRECT MEASURE.

SURVEYOR NOTE:
SURVEYOR HAS MADE NO INVESTIGATION OR
INDEPENDENT SEARCH FOR EASEMENTS OF RECORD,
ENCUMBRANCES, RESTRICTIVE COVENANTS, OWNERSHIP
TITLE EVIDENCE, OR ANY OTHER FACTS THAT AN
ACCURATE AND CURRENT TITLE SEARCH MAY DISCLOSE.

SITE BENCHMARK:
NORTH BONNET BOLT ON HYDRANT SHOWN
HEREIN. NAVD88 ELEVATION = 635.03


LEGEND

	LIMIT OF HEAVY DUTY FULL DEPTH PAVEMENT
	LIMIT OF STANDARD DUTY FULL DEPTH PAVEMENT



Know what's below.
Call before you dig.

UNDERGROUND UTILITIES OUPSTICKET#B930800476
UNDERGROUND UTILITIES AS SHOWN WERE LOCATED IN THE FIELD AND/OR TAKEN FROM
VARIOUS DEPARTMENT RECORDS. THE LOCATIONS ARE AS ACCURATE AS WE CAN
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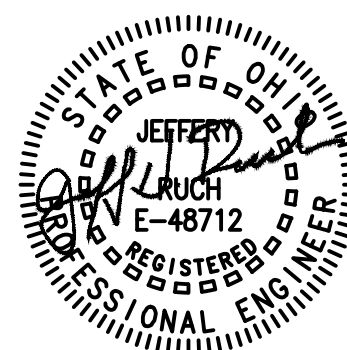


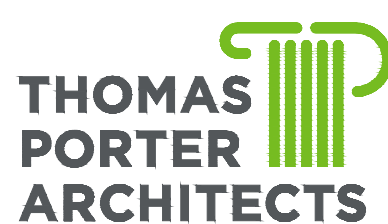8 North St. Clair - Toledo, Ohio 43604-1028
T 419.243.2400
www.thomasporterarchitects.com

CONSULTANTS:

ESA
Engineers, Surveyors & Associates, LLC
13855 Secor Rd., Toledo, Ohio, 43625 Phone (419) 475-9445

SEAL:



NOT FOR CONSTRUCTION UNLESS SIGNED & SEALED

SUMMER PAVING PROJECTS

MAUMEE CITY SCHOOLS

WAYNE TRAIL ELEMENTARY
1147 7TH STREET
MAUMEE, OHIO 43537

FAIRFIELD ELEMENTARY
1313 EASTFIELD ROAD
MAUMEE, OHIO 43537

PROJECT TITLE:

ISSUE OR REVISION:

3.05.2020	BID DOCUMENTS
2.21.2020	90% SUBMITTAL
DATE	ISSUE / REVISION

DESIGNED:	RGS,JHR
DRAWN:	RGS
CHECKED:	INITIALS

TPA COMMISSION NUMBER: 19060

DRAWING TITLE:

FAIRFIELD
ELEMENTARY
SITE UTILITY PLAN

DRAWING NUMBER:

C1.0

90
60
30
0 5 10 15 20
1"=30'
40
2
0 5 10 15 20
1"=20'
2
0 1 2 3 4 5 6
1 1/2"=1'-0"
1
0 1 2 3 4 5 6
3/4"=1'-0"
6
5
4
3
2
1
0 1 2 3 4 5 6
1 1/2"=1'-0"
3/8"=1'-0"

PARCEL: 3600194
OWNER: CITY OF MAUMEE
ADDRESS: 3215 EASTFIELD DR

PARCEL: 3600131
OWNER: CITY OF MAUMEE
ADDRESS: 3215 EASTFIELD DR

PARCEL: 3660288
OWNER: GREAT LAKES HOMES INC
ADDRESS: 0 EASTFIELD DR

PARCEL: 3600191
OWNER: MAUMEE CITY BOARD OF ED
ADDRESS: 3213 EASTFIELD DR

PARCEL: 3672795
OWNER: TRANS CON
BUILDERS INC

PARCEL: 3600901
OWNER: LECK DONALD C JR & DIANE M
ADDRESS: 1644 CASS RD

PARCEL: 3660891
OWNER: DARRAH JON & JULIA
ADDRESS: 1277 WESTFIELD DR

PARCEL: 3660894
OWNER: EAST JAY M & JULIE M
ADDRESS: 501 CENTERFIELD DR

PARCEL: 3660897
OWNER: JACOBS ROBERT JEFFERY
& PATRICIA L
ADDRESS: 505 CENTERFIELD DR

PARCEL: 3660901
OWNER: SHOOJA AYODEJI F
& TONI N
ADDRESS: 511 CENTERFIELD DR

PARCEL: 3660904
OWNER: PHILLIPS ERIC G
ADDRESS: 515 CENTERFIELD DR

PARCEL: 3660907
OWNER: COMMAGER ROGER J
& JULIE A
ADDRESS: 521 CENTERFIELD DR

PARCEL: 3660911
OWNER: DOLLEY STEPHEN R
& LINDA M
ADDRESS: 525 CENTERFIELD DR

PARCEL: 3660914
OWNER: ADAMS MIGNON PERRIN
ADDRESS: 531 CENTERFIELD DR

PARCEL: 3660917
OWNER: BURDGE BRYAN E SR
& CHARLENE D
ADDRESS: 535 CENTERFIELD DR

LEGEND

	AIR CONDITION UNIT		GAS VALVE		EXISTING SPOT ELEVATION
	BUSH		GUY WIRE		EXISTING TOP/CURB TOP/PVMT
	CATCH BASIN ROUND		IRON PIN FOUND		EXISTING CONTOUR
	CATCH BASIN SQUARE		LIGHT POLE		UNDERGROUND ELECTRIC
	CLEANOUT		POWER POLE		UNDERGROUND CABLE
	CONIFER TREE / (INCH)		SANITARY MANHOLE		FENCE LINE
	CONTROL POINT		SIGN		SANITARY SEWER LINE
	CURB INLET		SITE BENCHMARK		STORM SEWER LINE
	DECIDUOUS TREE / (INCH)		STEEL POST		GAS LINE
	DOWNSPOUT		STORM MANHOLE		WATER LINE
	ELECTRIC BOX		TRANSFORMER		OVERHEAD UTIL. WIRES
	ELECTRIC METER		TELEPHONE PEDESTAL		UNDERGROUND TELEPHONE
	ELECTRIC PEDESTAL		WATER MANHOLE		
	FIRE HYDRANT		WATER METER		
	FLAG POLE		WATER VALVE		
	GAS METER		WOOD POST		

EROSION CONTROL LEGEND


- (A) * YARD DRAIN SEDIMENT BARRIER
- (B) * CATCH BASIN SEDIMENT BARRIER
- (C) * FILTER FABRIC FENCE
- (D) PERMANENT SEEDING & MULCHING
- (E) MAINTAIN EXISTING VEGETATION
- [] LIMITS OF EARTH DISTURBING ACTIVITY (0.965± ACRES)
- * SEE SHEET C3.1 FOR DETAILS.



Know what's below.
Call before you dig.

SITE BENCHMARK:
NORTH BONNET BOLT ON HYDRANT SHOWN
HEREIN. NAVD88 ELEVATION = 635.03

UNDERGROUND UTILITIES OUPSTICKET#B930800476
UNDERGROUND UTILITIES AS SHOWN WERE LOCATED IN THE FIELD AND/OR TAKEN FROM VARIOUS DEPARTMENT RECORDS. THE LOCATIONS ARE AS ACCURATE AS WE CAN CONFIRM FROM SURFACE MANIFESTATIONS (E.G. VALVES, MANHOLES, ETC.), BUT NO EXCAVATION WAS DONE BY ESA ENGINEERS, SURVEYORS AND ASSOCIATES, LLC. THE EXACT LOCATION IS THE RESPONSIBILITY OF THE CONTRACTOR(S). BE SURE TO CALL THE OHIO UTILITIES PROTECTION SERVICE BEFORE STARTING ANY EXCAVATION AT 811.

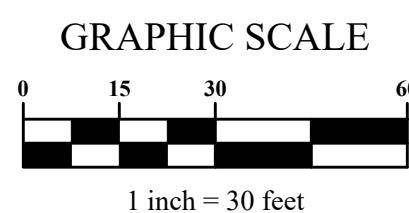


THOMAS
PORTER
ARCHITECTS

8 North St. Clair - Toledo, Ohio 43604-1028
T 419.243.2400
www.thomasporterarchitects.com

CONSULTANTS:

ESA
Engineers, Surveyors & Associates, LLC
13355 Secor Rd., Toledo, Ohio, 43623 Phone (419) 475-9445

SEAL:

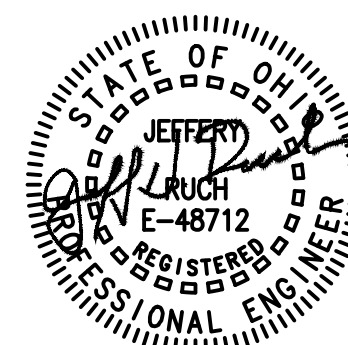

NOT FOR CONSTRUCTION UNLESS SIGNED & SEALED

SUMMER PAVING PROJECTS MAUMEE CITY SCHOOLS

WAYNE TRAIL ELEMENTARY
1147 7TH STREET
MAUMEE, OHIO 43537

FAIRFIELD ELEMENTARY
1313 EASTFIELD ROAD
MAUMEE, OHIO 43537

PROJECT TITLE:

ISSUE OR REVISION:

3.05.2020	BID DOCUMENTS
2.21.2020	90% SUBMITTAL


DATE	ISSUE / REVISION
DESIGNED:	RGS,JHR
DRAWN:	RGS
CHECKED:	INITIALS

TPA COMMISSION NUMBER: 19060

DRAWING TITLE:
FAIRFIELD
ELEMENTARY
EROSION CONTROL
PLAN

DRAWING NUMBER:

C1.2

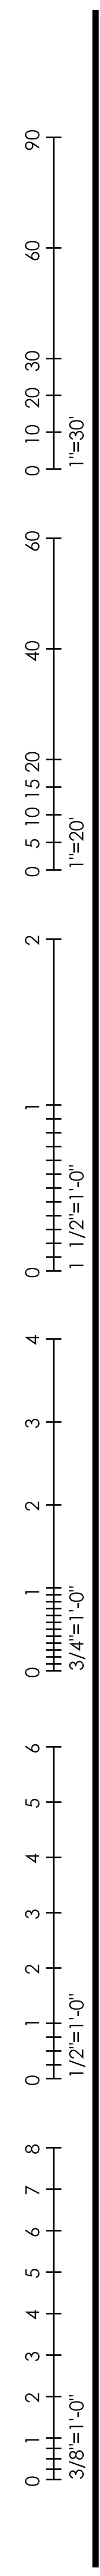

ALTERNATE #1
REPLACE EXISTING CONCRETE
SIDEWALK TO HIGH SCHOOL
PROPERTY WITH NEW 5'-0" WIDE
STANDARD DUTY CONCRETE
APPROX. 370 LF

ALTERNATE #1
REPLACE EXISTING CONCRETE
SIDEWALK TO HIGH SCHOOL
PROPERTY WITH NEW 5'-0" WIDE
STANDARD DUTY CONCRETE
APPROX 418 LF

SEAL-COAT EXISTING ASPHALT:
BY OWNER, N.I.C.

WAYNE TRAIL ELEMENTARY

SPECIAL NOTE:
CONTRACTOR TO PROVIDE FOR **475 TON #304**
VIRGIN AGGREGATE IN BASE BID ITEM 2.0.

CONTRACTOR TO PROVIDE FOR **75 TON #304**
VIRGIN AGGREGATE IN ALTERNATE #1.

REFERENCE SPECIFICATION SECTION 01010,
SUMMARY OF WORK.

REPLACE
PORTION OF
CONCRETE
SIDEWALK

SCRAPE AND PAINT EXISTING
HYDRANT SAFETY YELLOW

SITE PLAN LEGEND:

- | | | | |
|--|---|--|---|
| | NEW STANDARD DUTY CONCRETE SURFACE.
STANDARD DUTY DETAIL 3/A3.0 | | EXISTING CHAIN LINK OR SPLIT RAIL
FENCING/GATES TO REMAIN. |
| | NEW HEAVY DUTY CONCRETE SURFACE.
HEAVY DUTY DETAIL 3/A3.0 | | NEW OR EXISTING SITE SIGNAGE AS
NOTED AND SPECIFIED. |
| | NEW STANDARD DUTY ASPHALT SURFACE.
DETAIL 1/A3.0 | | PROPOSED BOLLARD, TYPE AS NOTED.
SEE DETAILS SHEET A3.0 |
| | NEW HEAVY DUTY ASPHALT SURFACE.
DETAIL 2/A3.0 | | TYPICAL TRAFFIC CONTROL PAVEMENT
MARKING. COLOR TO BE WHITE U.N.O. |
| | EXISTING BUILDING FOOTPRINT | | CONTROL JOINT |
| | GRADE AND SEED DISTURBED AREAS OF SITE.
TYPICAL THROUGHOUT OVERALL SITE AND
ENTIRE PROJECT. | | CONCRETE PAVEMENT
CONTROL/EXPANSION JOINT
MARKINGS. |
| | RE-MULCH DISTURBED AREAS OF PLAYGROUND | | EXPANSION JOINT |
| | MILL AND RESURFACE TOP ±1 1/2" EXISTING
ASPHALT WEARING COURSE | | INTEGRAL OR STANDALONE 4" CONCRETE CURB |
| | | | EXISTING DECIDUOUS OR CONIFEROUS
TREE OR SHRUB TO REMAIN U.N.O. |
| | | | NEW DECIDUOUS TREE |
| | | | EXISTING BENCH OR TABLE TO REMAIN |
| | | | SITE DIRECTIONAL SIGNAGE. SEE
DETAIL 6/A3.2 |
| | | | EXISTING FLAG POLE TO REMAIN |
| | | | PROPERTY LINES. SEE CIVIL DRAWINGS |
| | | | SIGNAGE TAG. SEE 3/A3.2 |

OVERALL WAYNE TRAIL SITE PLAN
1" = 20'

KEYED SITE PLAN NOTES

- | | |
|---|---|
| 1 | NOT USED AT WAYNE TRAIL ELEMENTARY |
| 2 | NEW DECIDUOUS TREE BY CONTRACTOR. COORDINATE SPECIES WITH OWNER/ARCHITECT. TOTAL NEW TREE CALIPER TO MATCH TOTAL CALIPER OF REMOVED TREES PER SITE. SEE DETAIL 5/A3.2 |
| 3 | NEW ASPHALT SPEED BUMP. SEE DETAIL 10/A3.0 |
| 4 | NOT USED AT WAYNE TRAIL ELEMENTARY |
| 5 | NOT USED AT WAYNE TRAIL ELEMENTARY |
| 6 | NOT USED AT WAYNE TRAIL ELEMENTARY |
| 7 | NOT USED AT WAYNE TRAIL ELEMENTARY |
| 8 | NOT USED AT WAYNE TRAIL ELEMENTARY |

CONSULTANTS:

esa

Engineers, Surveyors & Associates, LLC
5353 Secor Rd., Toledo, Ohio 43623 Phone (419) 475-9445

SEAL:



Andrew R. Knopp License #1817352
Expiration Date 12/31/2021
NOT FOR CONSTRUCTION UNLESS SIGNED & SEALED

SUMMER PAVING PROJECTS MAUMEE CITY SCHOOLS

WAYNE TRAIL ELEMENTARY
1147 7TH STREET
MAUMEE, OHIO 43537

FAIRFIELD ELEMENTARY
1313 EASTFIELD ROAD
MAUMEE, OHIO 43537

PROJECT TITLE:

ISSUE OR REVISION:

03.05.2020 BID DOCUMENTS

DATE ISSUE / REVISION

DESIGNED: ACH

DRAWN: ACH

CHECKED: JEA

TPA COMMISSION NUMBER: 19060



DRAWING TITLE:

WAYNE TRAIL ELEMENTARY SITE PLAN

DRAWING NUMBER:

A2.0

90
60
30
0 10 20 30
1"=30'
40
0 5 10 15 20
1"=20'
2
0 5 10 15 20
1"=20'
1
0 5 10 15 20
1"=20'
3/4"=1'-0"
4
0 5 10 15 20
3/4"=1'-0"
6
0 5 10 15 20
3/4"=1'-0"
8
0 5 10 15 20
3/4"=1'-0"
10
0 5 10 15 20
3/4"=1'-0"
12
0 5 10 15 20
3/4"=1'-0"

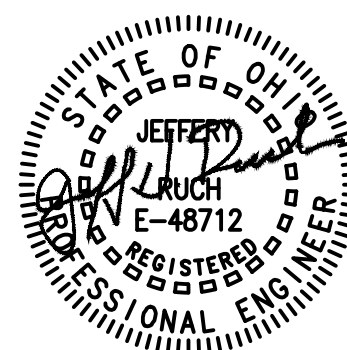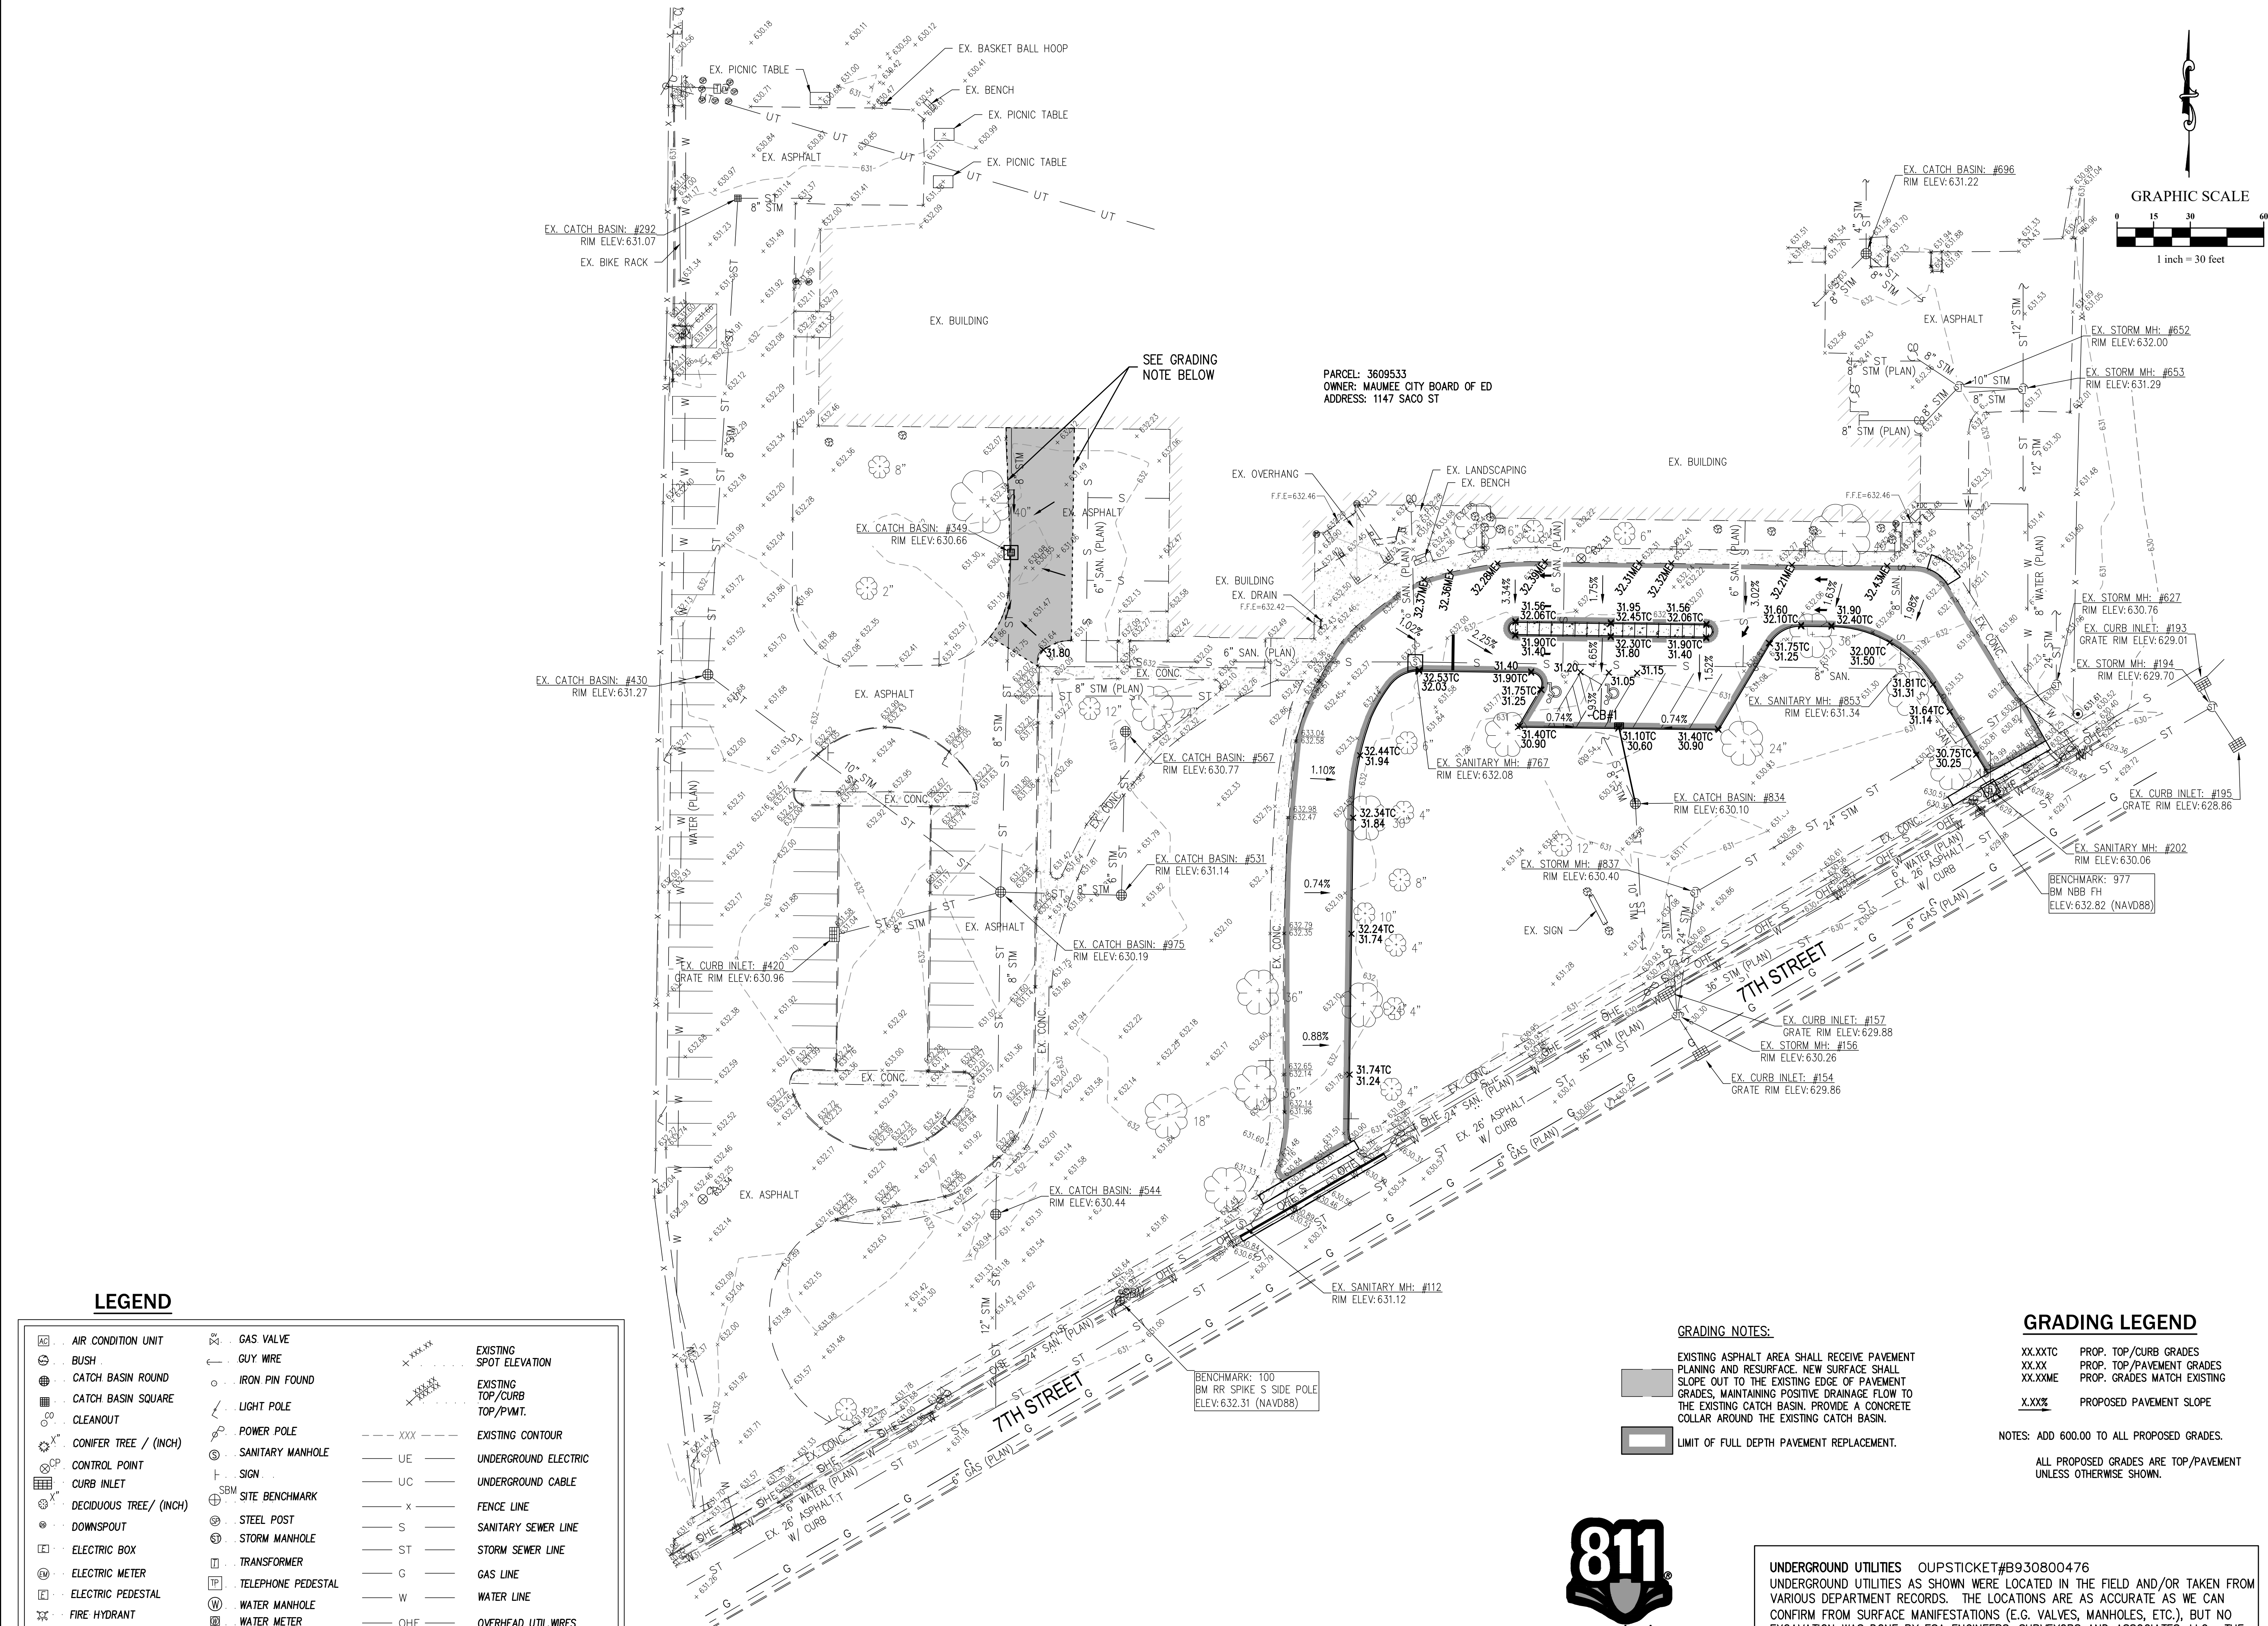

SUMMER PAVING PROJECTS
MAUMEE CITY SCHOOLS

WAYNE TRAIL ELEMENTARY
1147 7TH STREET
MAUMEE, OHIO 43537

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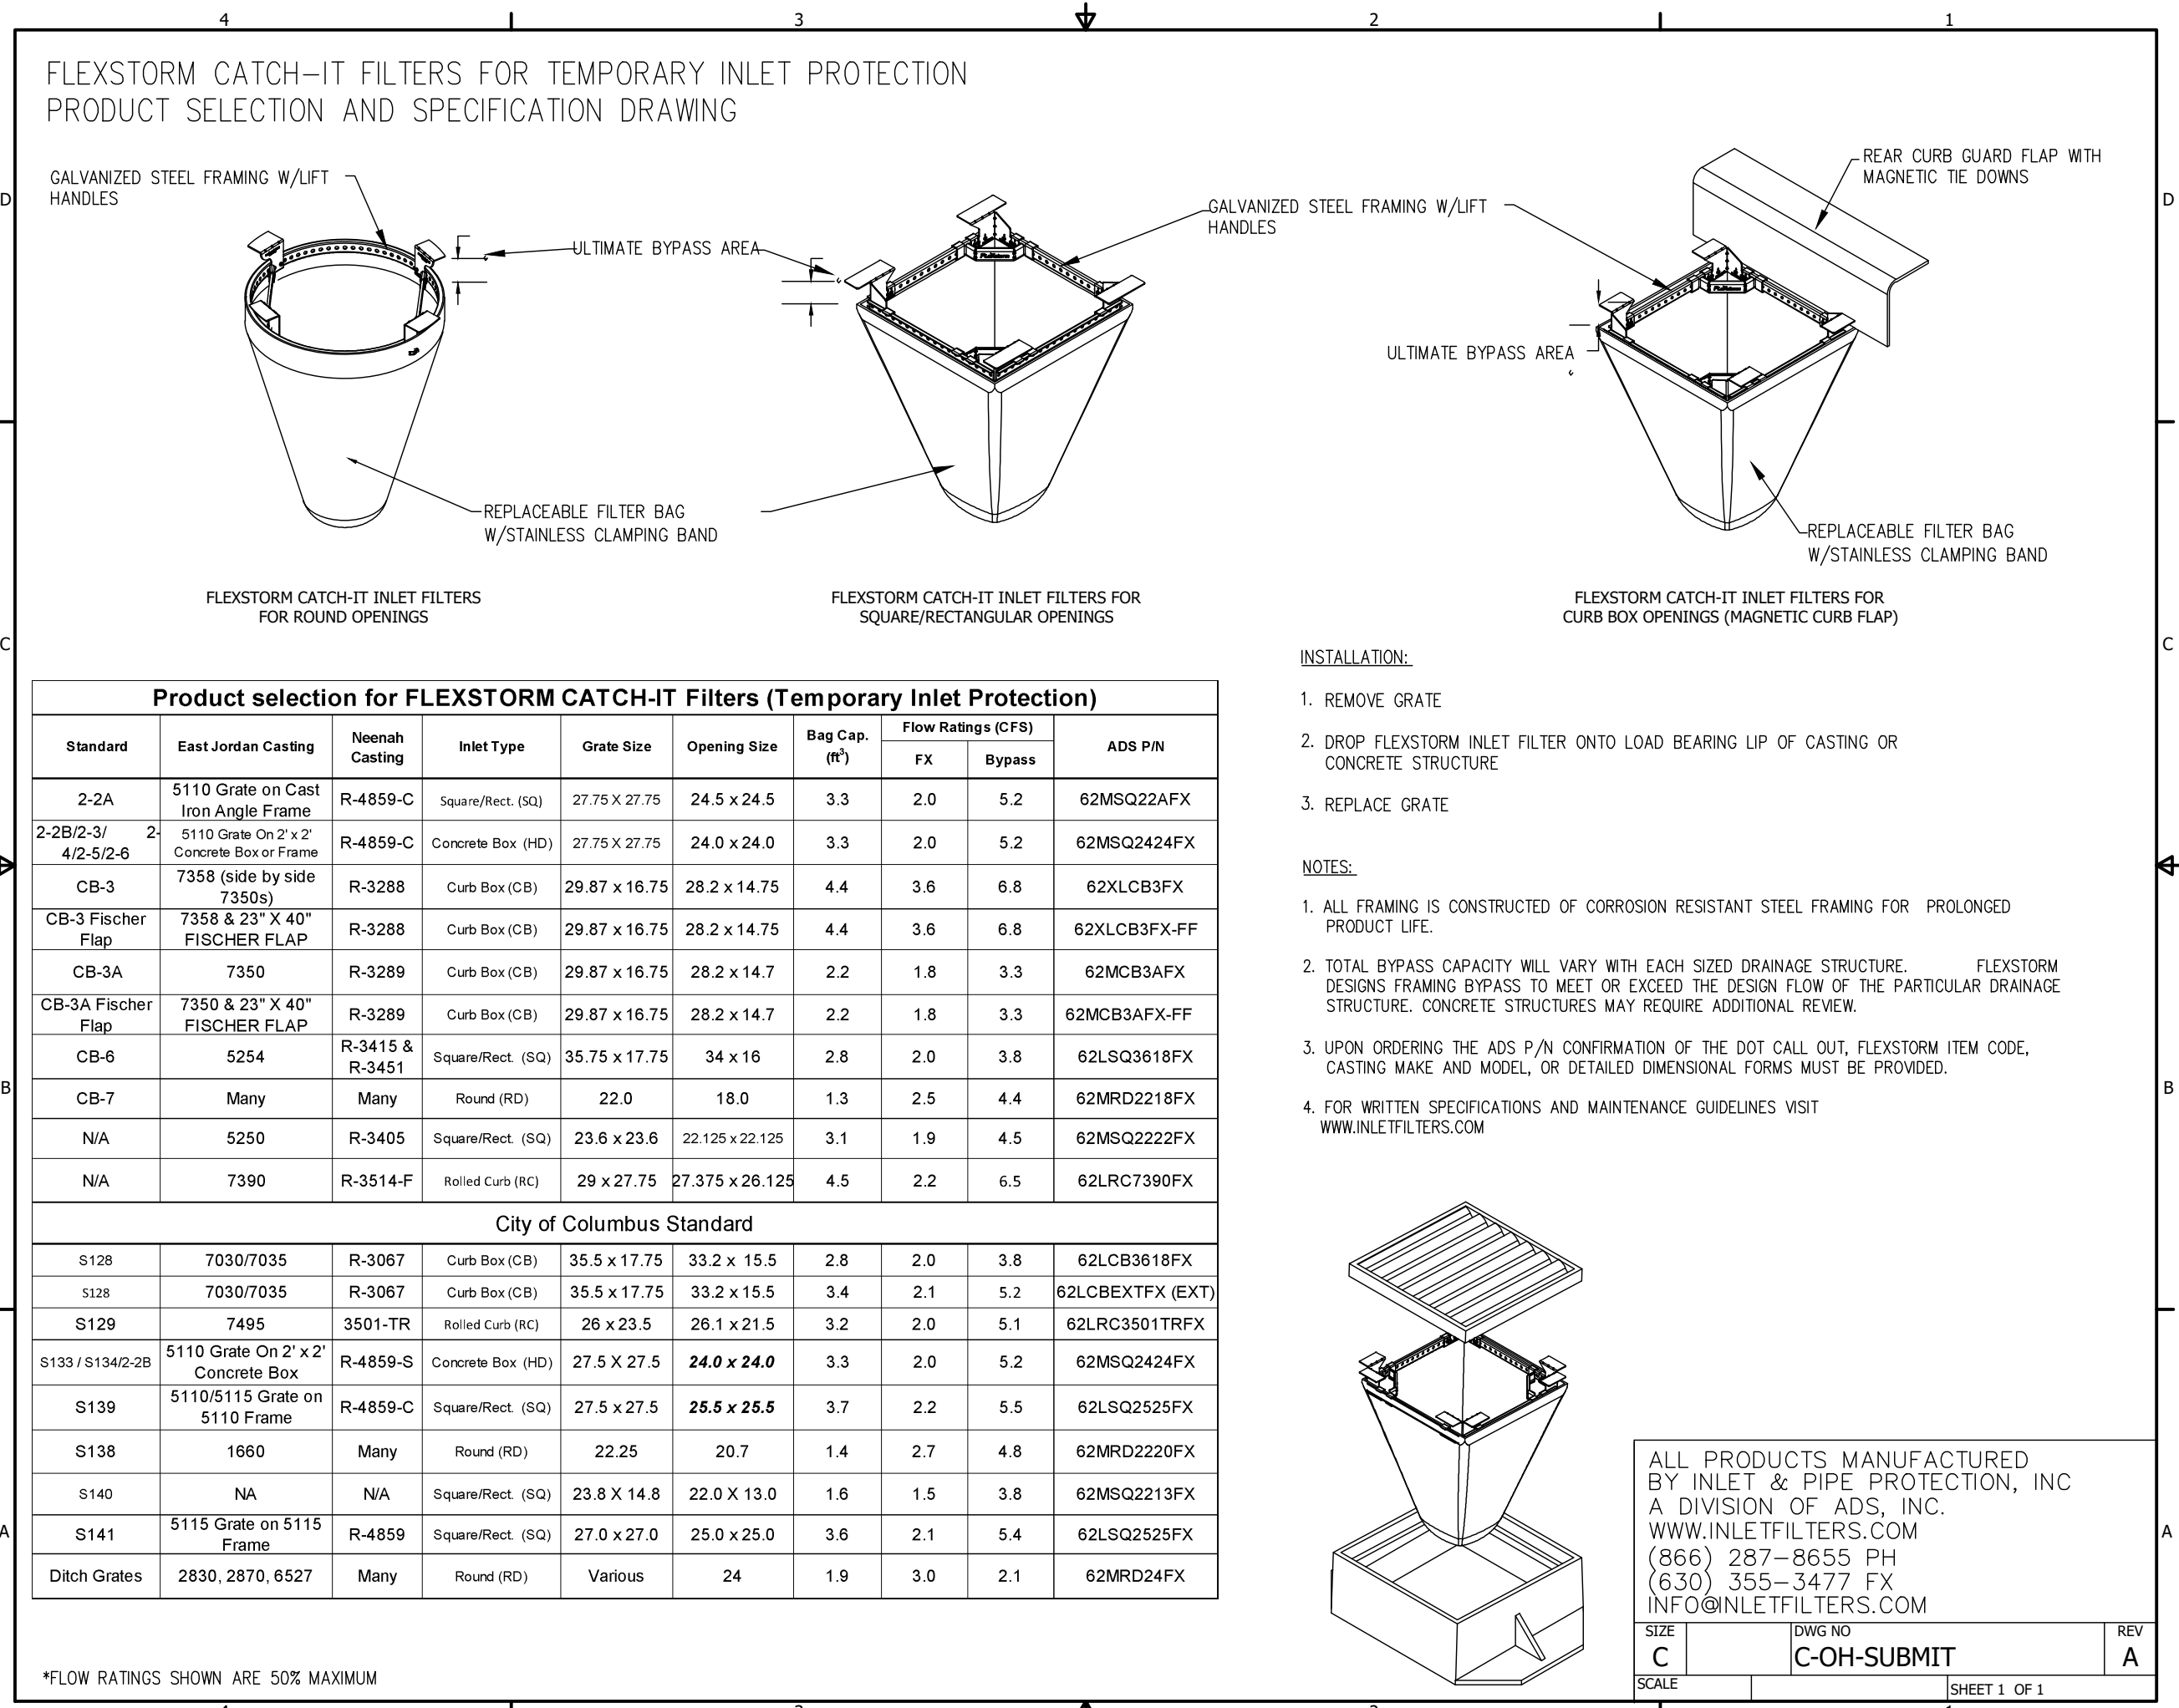
3.05.2020	BID DOCUMENTS
2.21.2020	90% SUBMITTAL
DATE	ISSUE / REVISION
DESIGNED:	RGS,JHR
DRAWN:	RGS
CHECKED:	INITIALS



UNDERGROUND UTILITIES OUPSTICKET#B930800476
UNDERGROUND UTILITIES AS SHOWN WERE LOCATED IN THE FIELD AND/OR TAKEN FROM VARIOUS DEPARTMENT RECORDS. THE LOCATIONS ARE AS ACCURATE AS WE CAN CONFIRM FROM SURFACE MANIFESTATIONS (E.G. VALVES, MANHOLES, ETC.), BUT NO EXCAVATION WAS DONE BY ESA ENGINEERS, SURVEYORS AND ASSOCIATES, LLC. THE EXACT LOCATION IS THE RESPONSIBILITY OF THE CONTRACTOR(S). BE SURE TO CALL THE OHIO UTILITIES PROTECTION SERVICE BEFORE STARTING ANY EXCAVATION AT 811.




90
60
30
0 10 20 30
1"=30'
60
40
0 5 10 15 20
1"=20'
2
0 1 2 3 4
1 1/2"=1'-0"
1
0 1 2 3 4
3/4"=1'-0"
6
5
4
3
2
1
0 1 2 3 4
1 1/2"=1'-0"
8
7
6
5
4
3
2
1
0 1 2 3 4
3/8"=1'-0"



SOIL EROSION & SEDIMENTATION CONTROL NOTES:

1. ALL WORK SHALL BE IN ACCORDANCE WITH OHIO EPA NPDES CONSTRUCTION STORM WATER GENERAL PERMIT (NO: OHC000005). SOIL EROSION CONTROL MEASURES SHALL CONFORM WITH THE SPECIFICATIONS OF OHIO'S RAINWATER AND LAND DEVELOPMENT MANUAL BEST MANAGEMENT PRACTICES (BMP).
2. AN SWP3 IS REQUIRED FOR ALL PROJECTS THAT DISTURB 1 ACRE OR MORE AND MUST BE MAINTAINED ON SITE AT ALL TIMES DURING CONSTRUCTION ACTIVITIES.
3. A NOTICE OF INTENT (NOI) APPLICATION MUST BE FILED WITH THE OHIO EPA FOR ALL PROJECTS THAT DISTURB 1 ACRE OR MORE AT LEAST 21 DAYS PRIOR TO THE START OF ANY CONSTRUCTION ACTIVITY.
 - A. ALL "OPERATORS" MUST OBTAIN PERMIT COVERAGE BEFORE BREAKING GROUND. THIS INCLUDES CONTRACTORS ASSOCIATED WITH AND RESPONSIBLE FOR THE SOIL EROSION ACTIVITIES.
 - B. THESE "OPERATORS" MUST FILE A CO-PERMITTEE NOI WITH THE OHIO EPA. THIS IS THE SOLE RESPONSIBILITY OF THE CO-PERMITTEE.
4. THE CONTRACTOR SHALL PROVIDE REGULAR INSPECTIONS AND MAINTENANCE FOR ALL SOIL EROSION CONTROL PRACTICES.
5. SOIL EROSION AND SEDIMENTATION BEST MANAGEMENT PRACTICE (BMP) MEASURES WILL BE INSTALLED PRIOR TO START OF ANY CONSTRUCTION AND WILL BE MAINTAINED AT ALL TIMES UNTIL CONSTRUCTION HAS BEEN COMPLETED, INCLUDING ALL GRASS BEING WELL ESTABLISHED AND/OR PERMANENT EROSION AND SEDIMENTATION BMP MEASURES ARE IN PLACE.
6. CONTRACTOR SHALL INSTALL A STABILIZED CONSTRUCTION ENTRANCE TO CONTROL EROSION PRIOR TO COMMENCEMENT OF ANY EARTHWORK OPERATIONS. DRIVEWAY SURFACE SHALL BE COMPOSED OF 3" CLEAN AGGREGATE. CONTRACTOR SHALL BE RESPONSIBLE FOR MAINTENANCE OF THIS ACCESS ROUTE WHEN CONDITIONS WARRANT.
7. CONTRACTOR TO DESIGNATE A SITE DUMP/WASH AREA PRIOR TO STARTING CONSTRUCTION FOR SUCH PURPOSES AS WASHING OUT CONCRETE TRUCKS AND DUMPING NON-HAZARDOUS WASTE MATERIALS. SUBJECT TO THE SUPERVISION OF THE LOCAL GOVERNING AGENCIES. DUMPING OR DISCHARGE OF ANY WASTE MATERIALS TO ANY CITY OF MAUMEE SEWERS IS PROHIBITED. HAZARDOUS WASTES ARE TO BE REMOVED OFF SITE AND PROPERLY DISPOSED OF CONSISTENT WITH ALL FEDERAL, STATE AND LOCAL REGULATIONS.
8. ALL TEMPORARY AND PERMANENT CONTROL PRACTICES MUST BE MAINTAINED AND REPAIRED TO ENSURE CONTINUED PERFORMANCE.
9. PERIMETER SEDIMENT BARRIERS SHALL BE IMPLEMENTED AS THE FIRST STEP OF GRADING AND WITHIN 7 DAYS FROM THE START OF GRUBBING.
10. ALL DISTURBED AREAS THAT WILL REMAIN DORMANT FOR MORE THAN 14 DAYS MUST BE TEMPORARILY STABILIZED WITHIN 7 DAYS.
11. TEMPORARY INLET PROTECTION SHALL BE PROVIDED AND MAINTAINED THROUGHOUT THE DURATION OF CONSTRUCTION FOR ALL CATCH BASINS ON SITE.
12. SHEET FLOW RUNOFF FROM DENUDEU AREAS SHALL BE INTERCEPTED BY SEDIMENT BARRIERS.
13. PERMANENT STABILIZATION SHALL BE APPLIED TO DISTURBED AREAS WITHIN 7 DAYS AFTER FINAL GRADE IS REACHED AND FOR AREAS THAT WILL LIE DORMANT FOR ONE YEAR OR MORE.
14. CONSTRUCTION OPERATIONS SHALL BE SCHEDULED AND PERFORMED SO THAT PREVENTIVE SOIL EROSION CONTROL MEASURES ARE IN PLACE PRIOR TO EXCAVATION IN CRITICAL AREAS AND TEMPORARY STABILIZATION MEASURES ARE IN PLACE IMMEDIATELY FOLLOWING BACKFILLING OPERATIONS.
15. CONTRACTOR SHALL PROVIDE ROUTINE STREET SWEEPING TO ENSURE MINIMAL EROSION INTO THE PUBLIC STORM SEWER SYSTEM AND ROADWAY. CLEANUP WILL BE CONDUCTED IN A MANNER TO ENSURE THAT EROSION CONTROL MEASURES ARE NOT DISTURBED.
16. STOCKPILED SOILS SHALL BE LEGALLY REMOVED FROM THE SITE OR SEEDED AND SURROUNDED WITH SILT FENCE UNTIL SUCH TIME THAT IT CAN BE REUSED ON SITE.
17. A NOTICE OF TERMINATION (NOT) SHALL BE SUBMITTED WITHIN 45 DAYS OF COMPLETING ALL LAND DISTURBANCE ACTIVITIES.

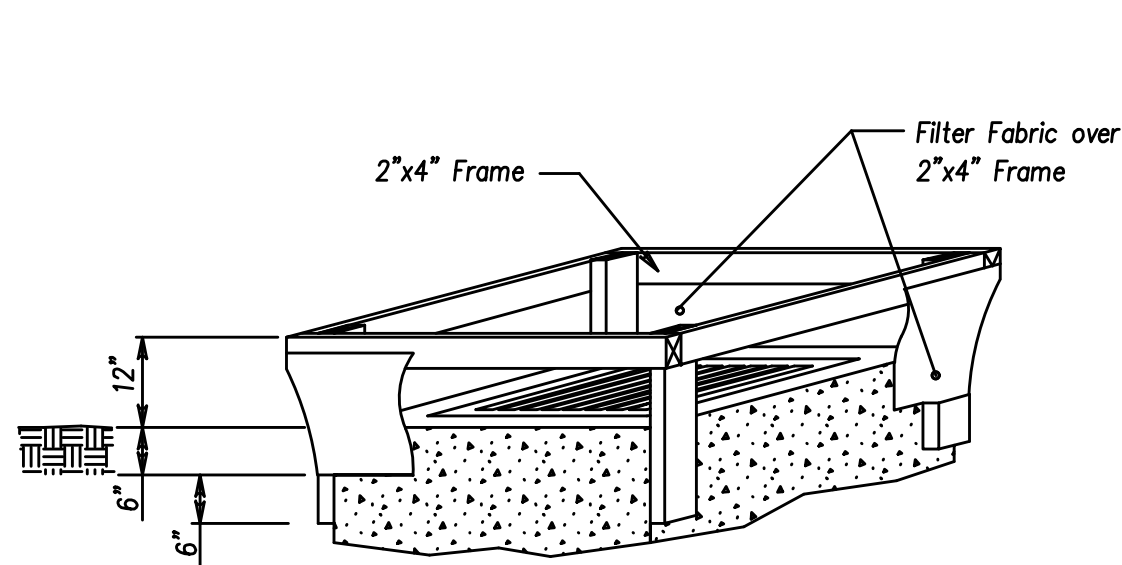

NOTES


MATERIALS: Filter fabric shall meet the requirements of CMS 712.09, Type C. Support stakes shall be a minimum of 1.5"x1.5", nominal, and shall be hardwood of sound quality. The stakes shall be driven a minimum of 6" below the bottom of the filter fabric. The maximum spacing between support stakes shall be 10'.

CONSTRUCTION: The bottom of the fabric shall be buried 6" below the ground. The ends of adjacent sections of fence shall be overlapped with the end stake of each section wrapped together prior to installation. The ground elevation of the fence shall be held constant except that the end elevations shall be raised upslope to prevent flow around the end of the fence.

MAINTENANCE: The filter fabric fence shall be maintained to be functional. This shall include removal of trapped sediment and required cleaning, repair, and replacement of the filter fabric. The maintenance or replacement cost will be paid for by the Department under unit bid prices, agreed unit prices, or CMS 109.04.


PAYMENT: The cost of all materials, construction and removal shall be paid for under Item 207 - Temporary Perimeter Filter Fabric Fence or Temporary Ditch Check Filter Fabric Fence, Linear Foot.

TEMPORARY INLET PROTECTION FILTER FABRIC FENCE

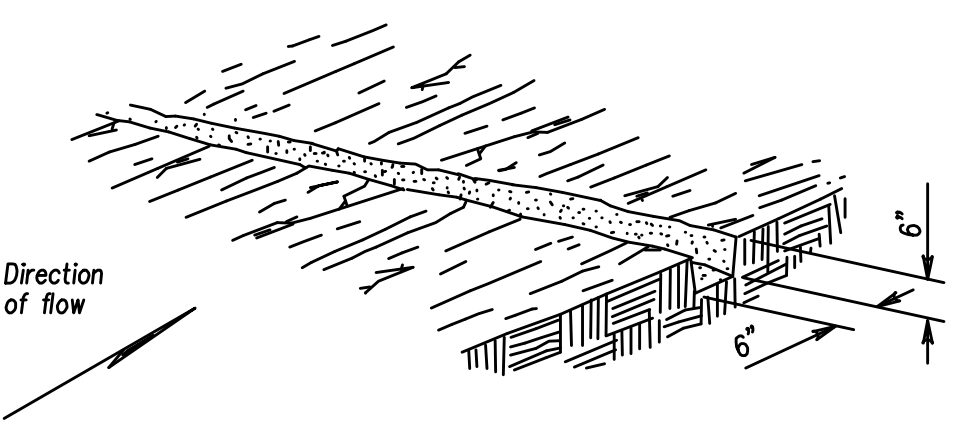


Excavate a 6"x6" trench
along the proposed fence line.

STEP 1

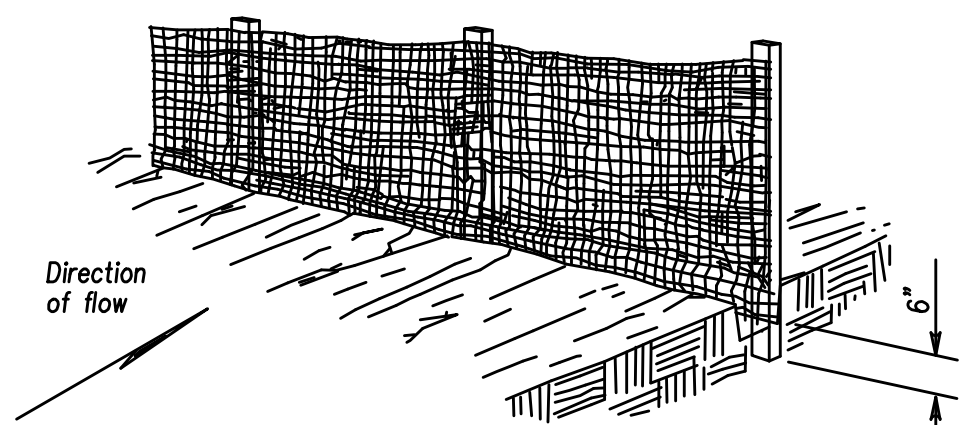

Place fabric and support stakes
and extend fabric into the trench.

STEP 2

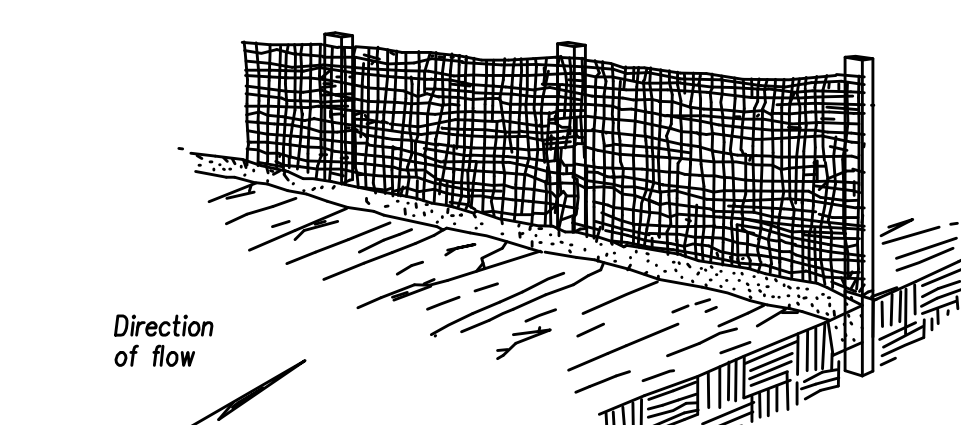

Backfill and compact the excavated soil.

STEP 3

PLACEMENT AND CONSTRUCTION OF
PERIMETER FILTER FABRIC FENCE

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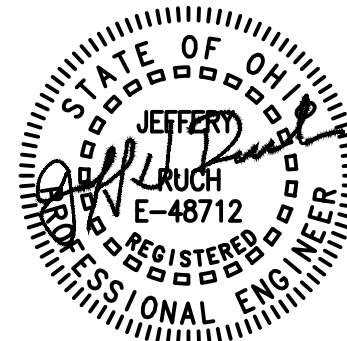
8 North St. Clair - Toledo, Ohio 43604-1028
T 419.243.2400
www.thomasporterarchitects.com

CONSULTANTS:

ESA

Engineers, Surveyors & Associates, LLC
13333 Secor Rd., Toledo, Ohio, 43623 Phone (419) 475-9445

SEAL:



NOT FOR CONSTRUCTION UNLESS SIGNED & SEALED

SUMMER PAVING PROJECTS
MAUMEE CITY SCHOOLS

WAYNE TRAIL ELEMENTARY
1147 7TH STREET
MAUMEE, OHIO 43537

FAIRFIELD ELEMENTARY
1313 EASTFIELD ROAD
MAUMEE, OHIO 43537

PROJECT TITLE:

ISSUE OR REVISION:

3.05.2020	BID DOCUMENTS
2.21.2020	90% SUBMITTAL
DATE	ISSUE / REVISION
DESIGNED:	RGS,JHR
DRAWN:	RGS
CHECKED:	INITIALS



TPA COMMISSION NUMBER: 19060

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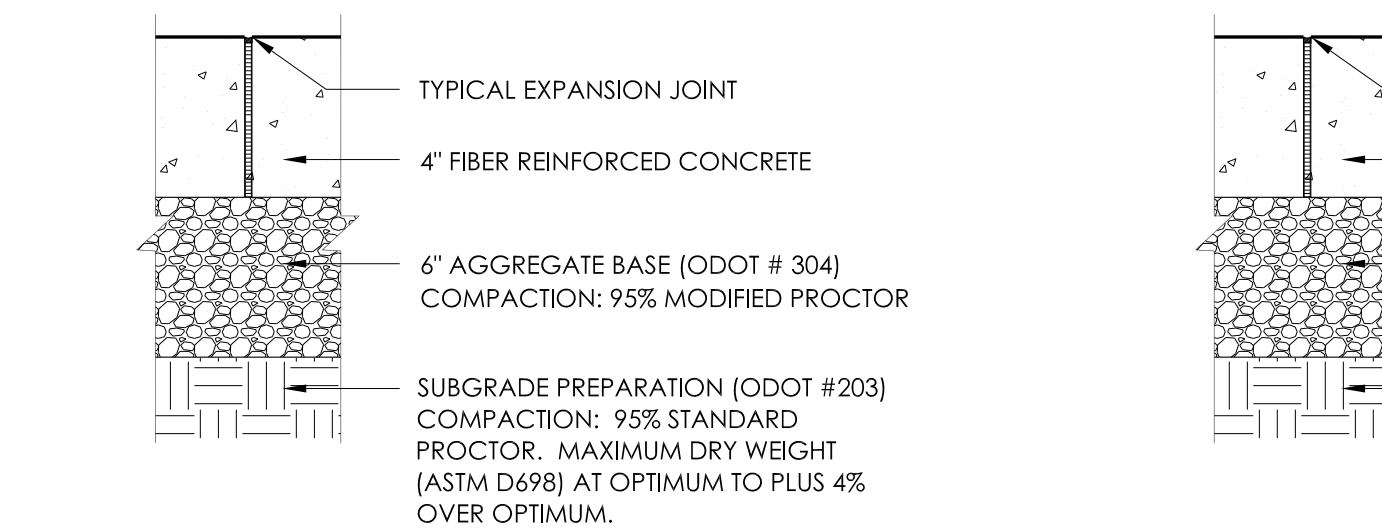
EROSION CONTROL
NOTES AND DETAILS

DRAWING NUMBER:


C3.1

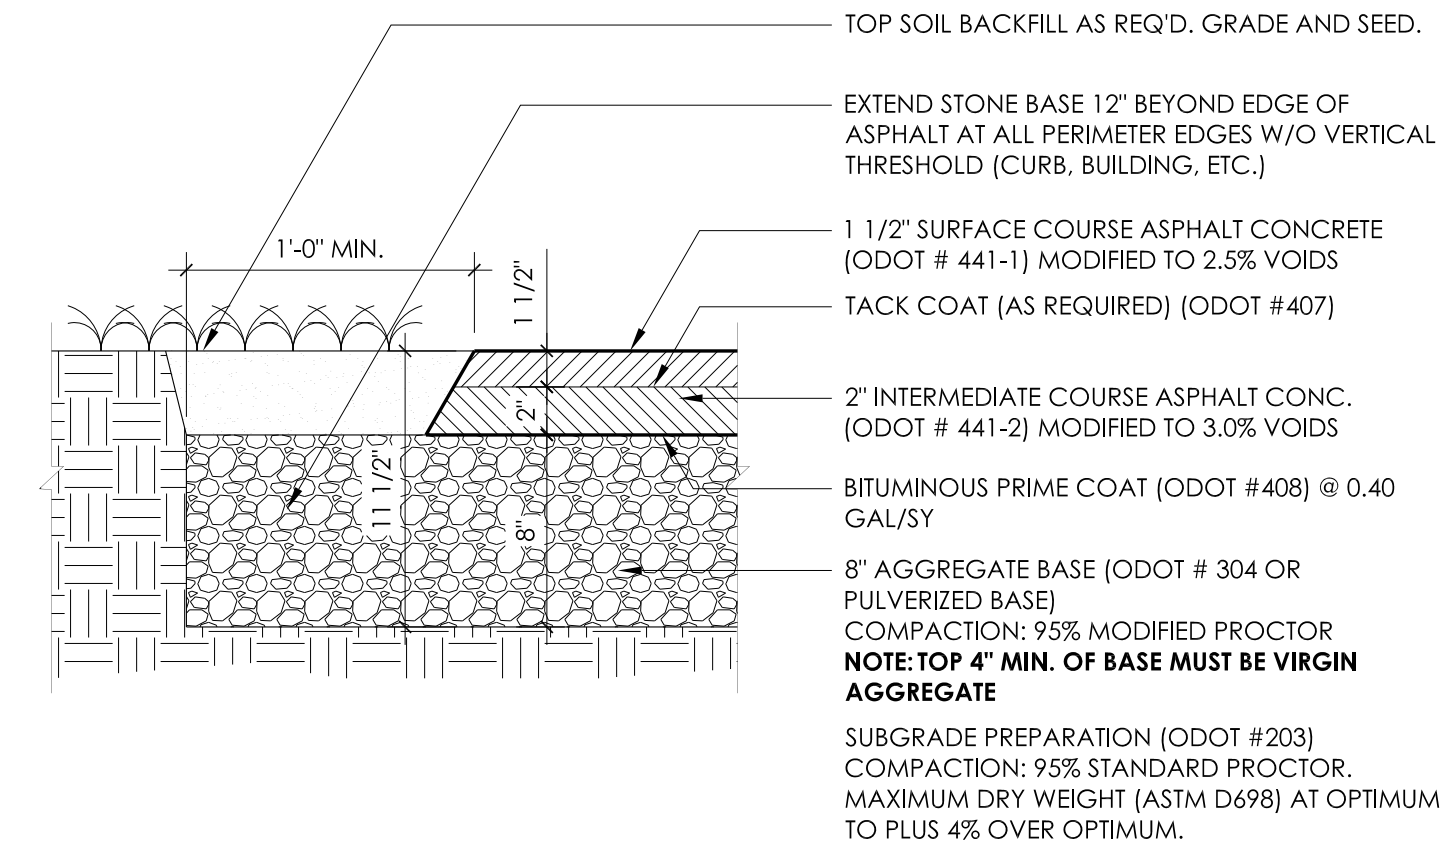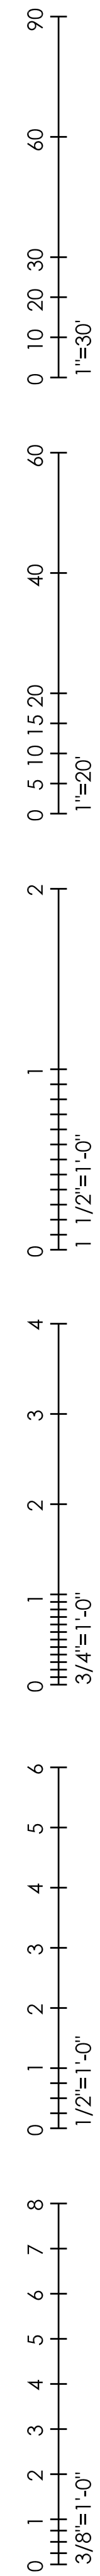


1 STANDARD DUTY PAVEMENT AT GRADE
A3.0 SCALE: 1 1/2" = 1' 0"



STANDARD DUTY CONCRETE

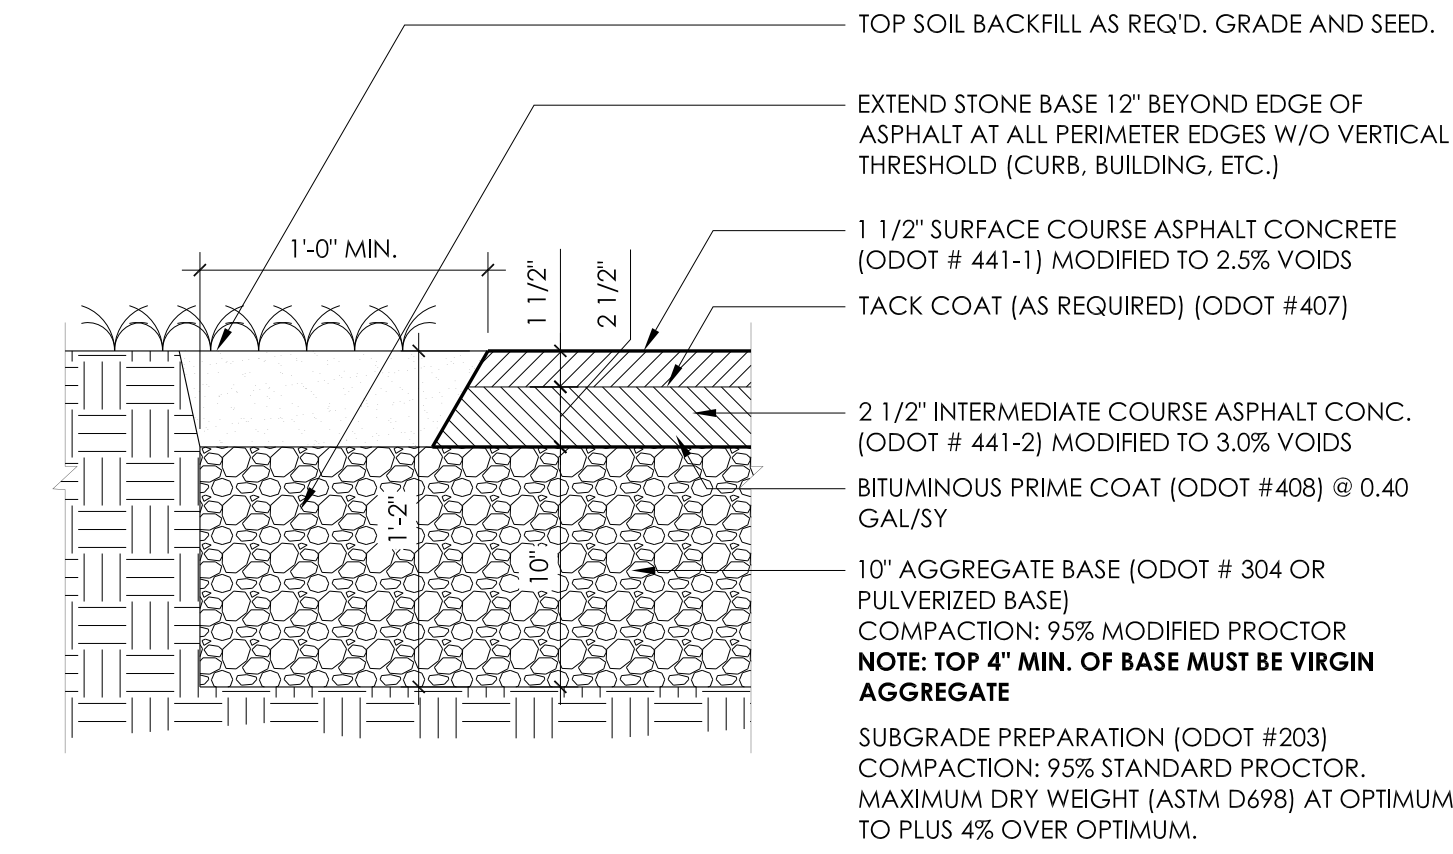

2 HEAVY DUTY PAVEMENT AT GRADE
A3.0 SCALE: 1 1/2" = 1' 0"

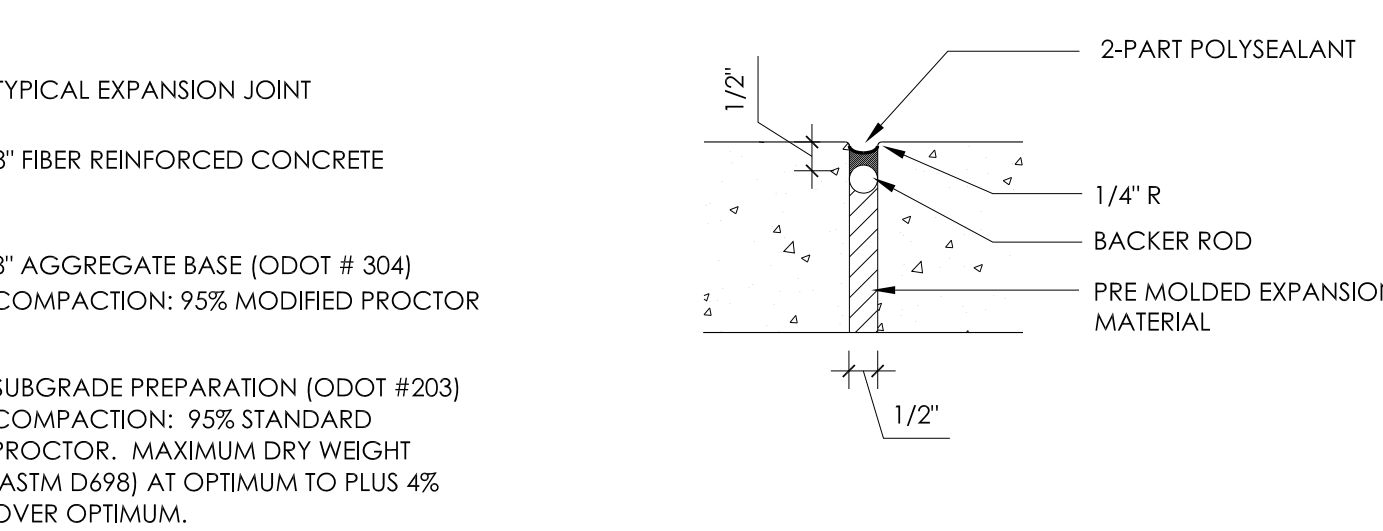


HEAVY DUTY CONCRETE


- TYPICAL ASPHALTIC PAVEMENT NOTES:
1. BITUMINOUS CONCRETE UTILIZED FOR THIS PROJECT SHOULD CONFORM TO ODOT ITEM 441.
 2. BASE AND BINDER COURSE MATERIAL SHOULD MEET JOB FORMULA LIMITS OUTLINED IN 441.02, TABLE A, TYPE 2. SURFACE OR WEARING COURSES SHOULD FALL WITHIN TYPE 1 LIMITS. BOTH SHOULD BE DESIGNED FOR MEDIUM TRAFFIC. THE ASPHALT BINDER MATERIAL SHALL BE PG 64-22.
 3. ALL BITUMINOUS MATERIAL SHALL BE COMPACTED TO A DENSITY OF 97% OF THE MAXIMUM DENSITY AS DETERMINED BY THE MARSHALL METHOD.
 4. RECLAIMED PAVEMENT SHALL NOT BE ALLOWED IN THE WEARING COURSE.

- TYPICAL CONCRETE NOTES:
1. CONTROL JOINTS ARE TO BE 1/4 DEPTH OF SLAB TOOLED WITH 1/4" RADIUS. CONTROL JOINT METHOD MUST BE UNIFORM THROUGHOUT THE PROJECT.
 2. EXPANSION JOINTS TO BE 30'-0" O.C.. CONTROL JOINTS ARE TO BE 6'-0" O.C. OR AS SHOWN ON PLAN.
 3. PROVIDE LIGHT BROOM FINISH PERPENDICULAR TO TRAFFIC ON ALL CONCRETE SURFACES AFTER JOINT AND EDGE TOOLING TO AVOID TOOL MARKS.
 4. PROVIDE 1/4" RADIUS ON ALL SLAB EDGES UNLESS NOTED OTHERWISE.
 5. EXPANSION JOINTS SHALL BE PROVIDED WHERE CONCRETE PAVEMENT IS ADJACENT TO VERTICAL THRESHOLDS (BUILDING WALLS/FOUNDATIONS) OR WHERE NEW PAVING MEETS EXISTING PAVING.
 6. EXPANSION JOINTS ARE TO BE 1/2" THICK. PRE-FORMED FILLER. HOLD FILLER DOWN 1/2" FROM FINISHED SURFACE AND CAULK JOINT WITH SEALANT.


EXPANSION JOINT DETAIL

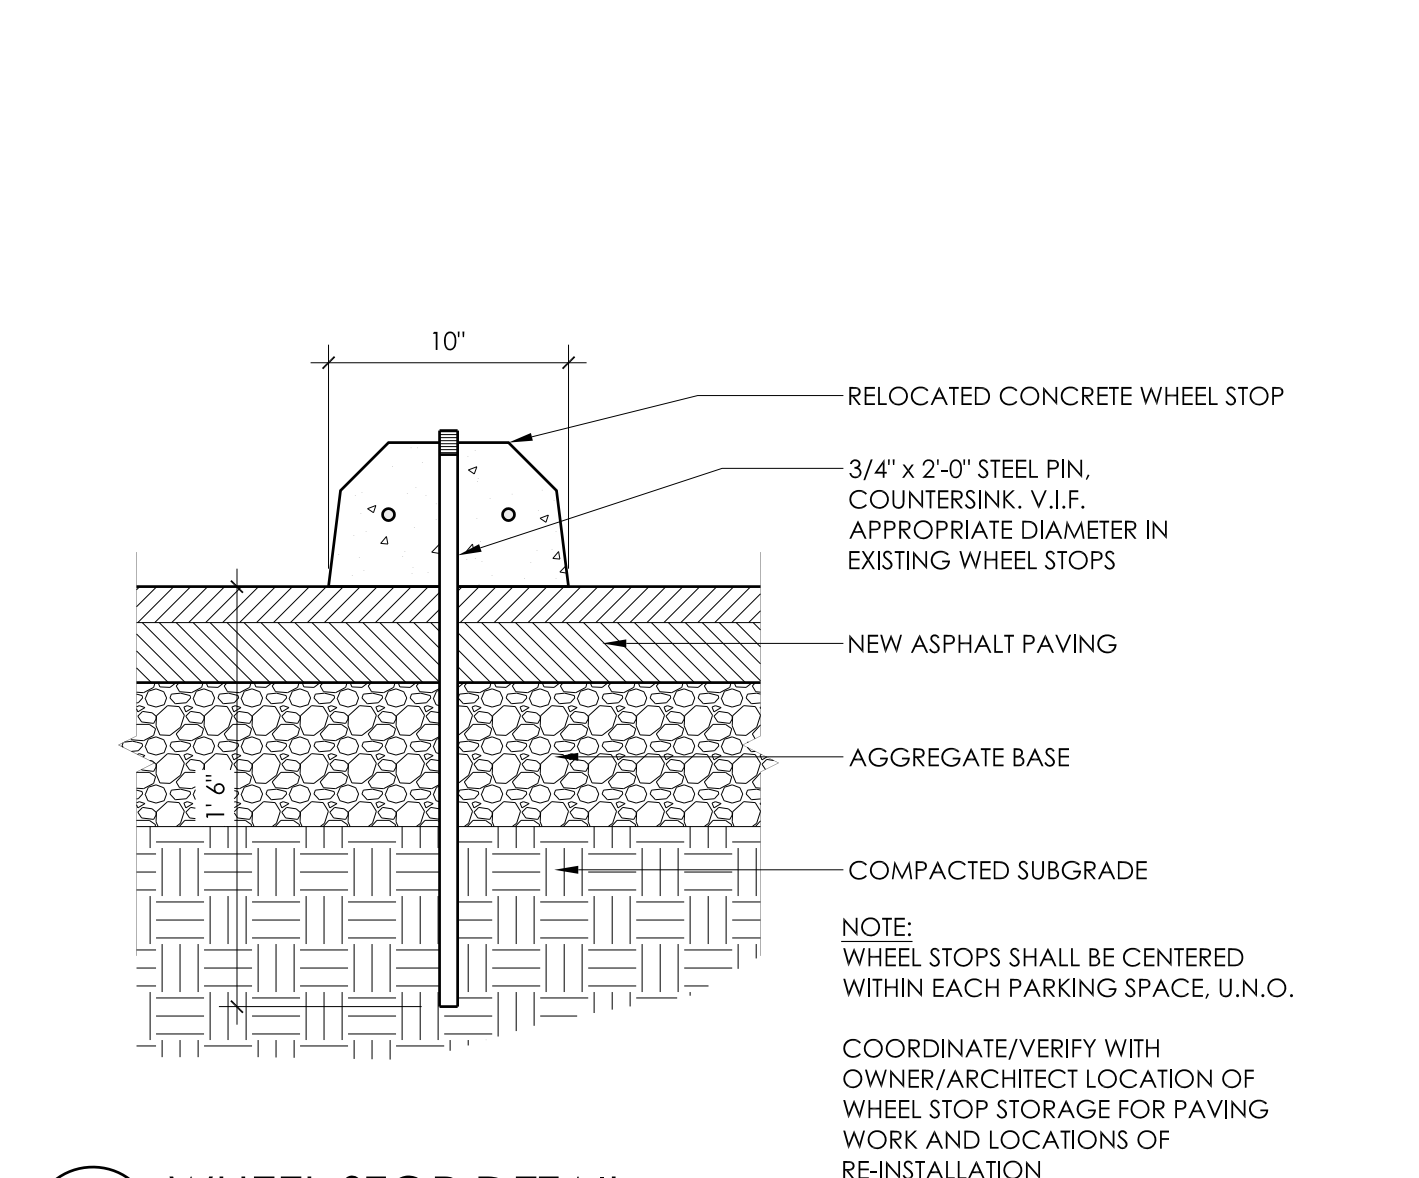


8 WHEEL STOP DETAIL
A3.0 SCALE: 1 1/2" = 1' 0"

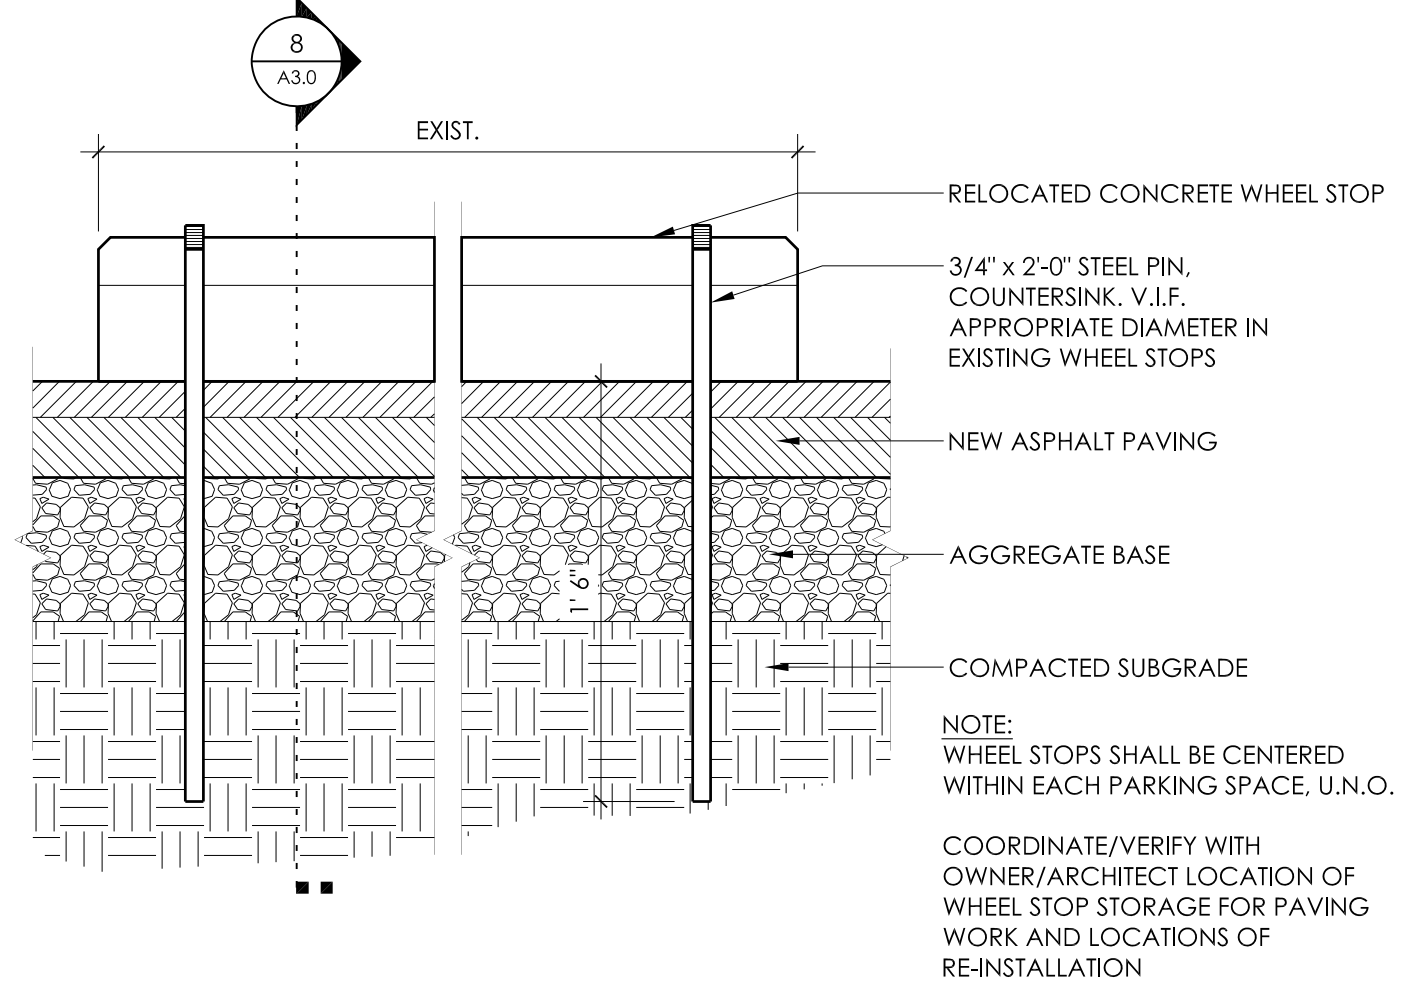


9 WHEEL STOP DETAIL
A3.0 SCALE: 1 1/2" = 1' 0"

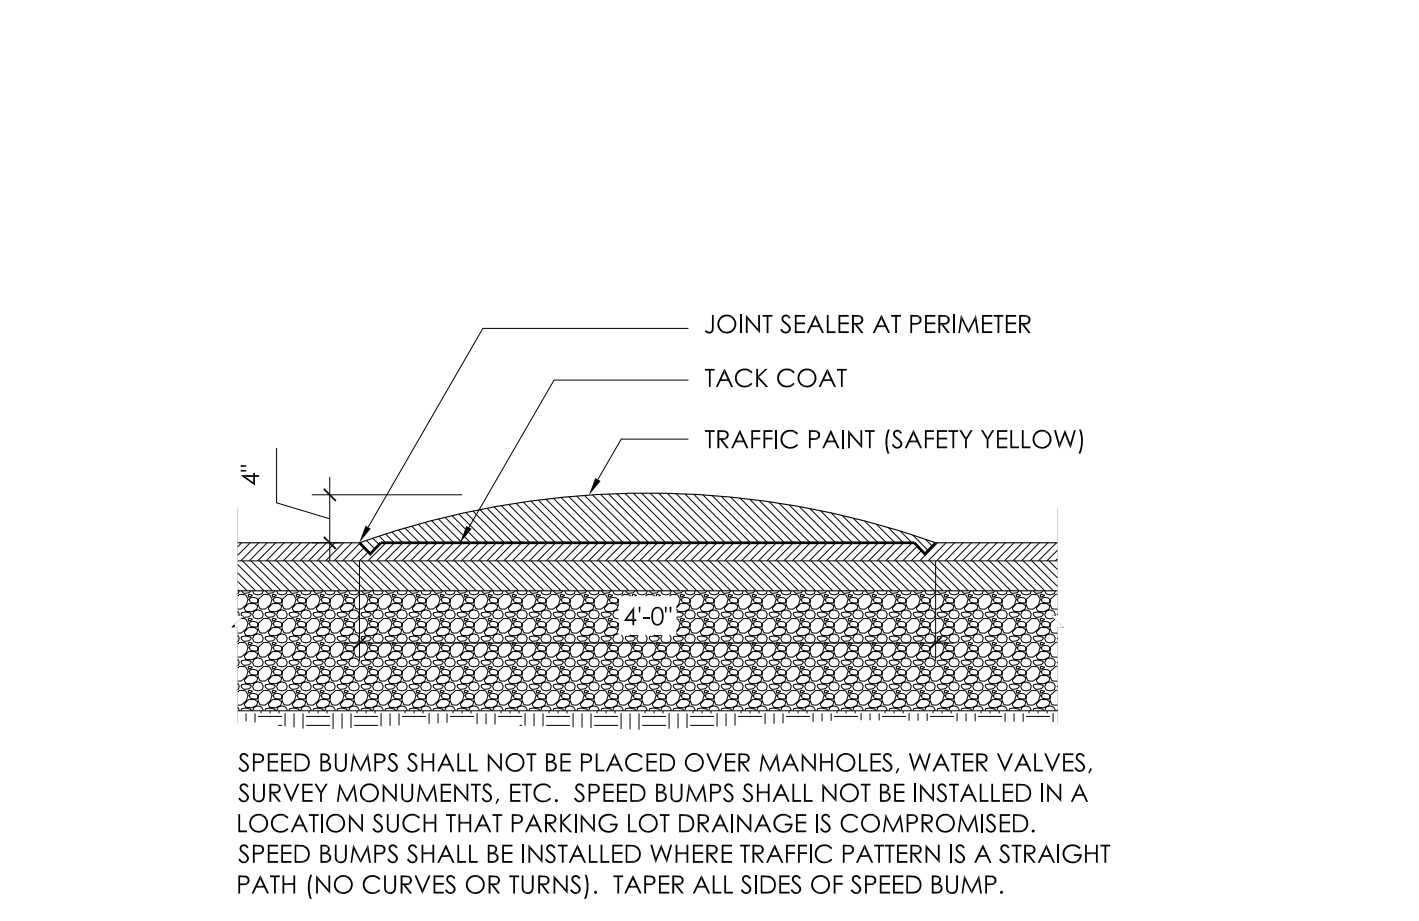


10 ASPHALT SPEED BUMP DETAIL
A3.0 SCALE: 3/4" = 1'-0"

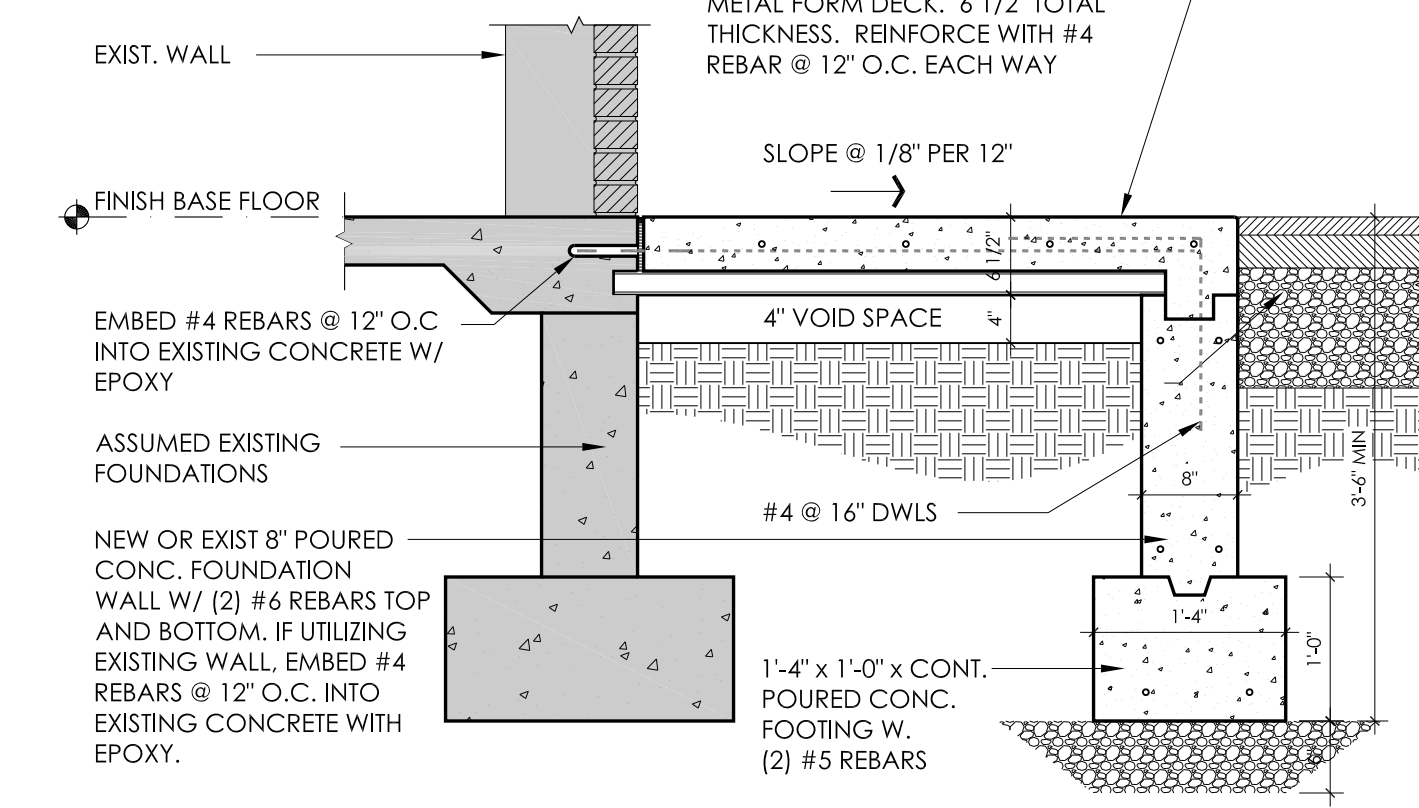

11 CONCRETE STOOP DETAIL - FAIRFIELD
A3.0 SCALE: 3/4" = 1'-0" SEE SHEET A1.0 FOR LOCATION

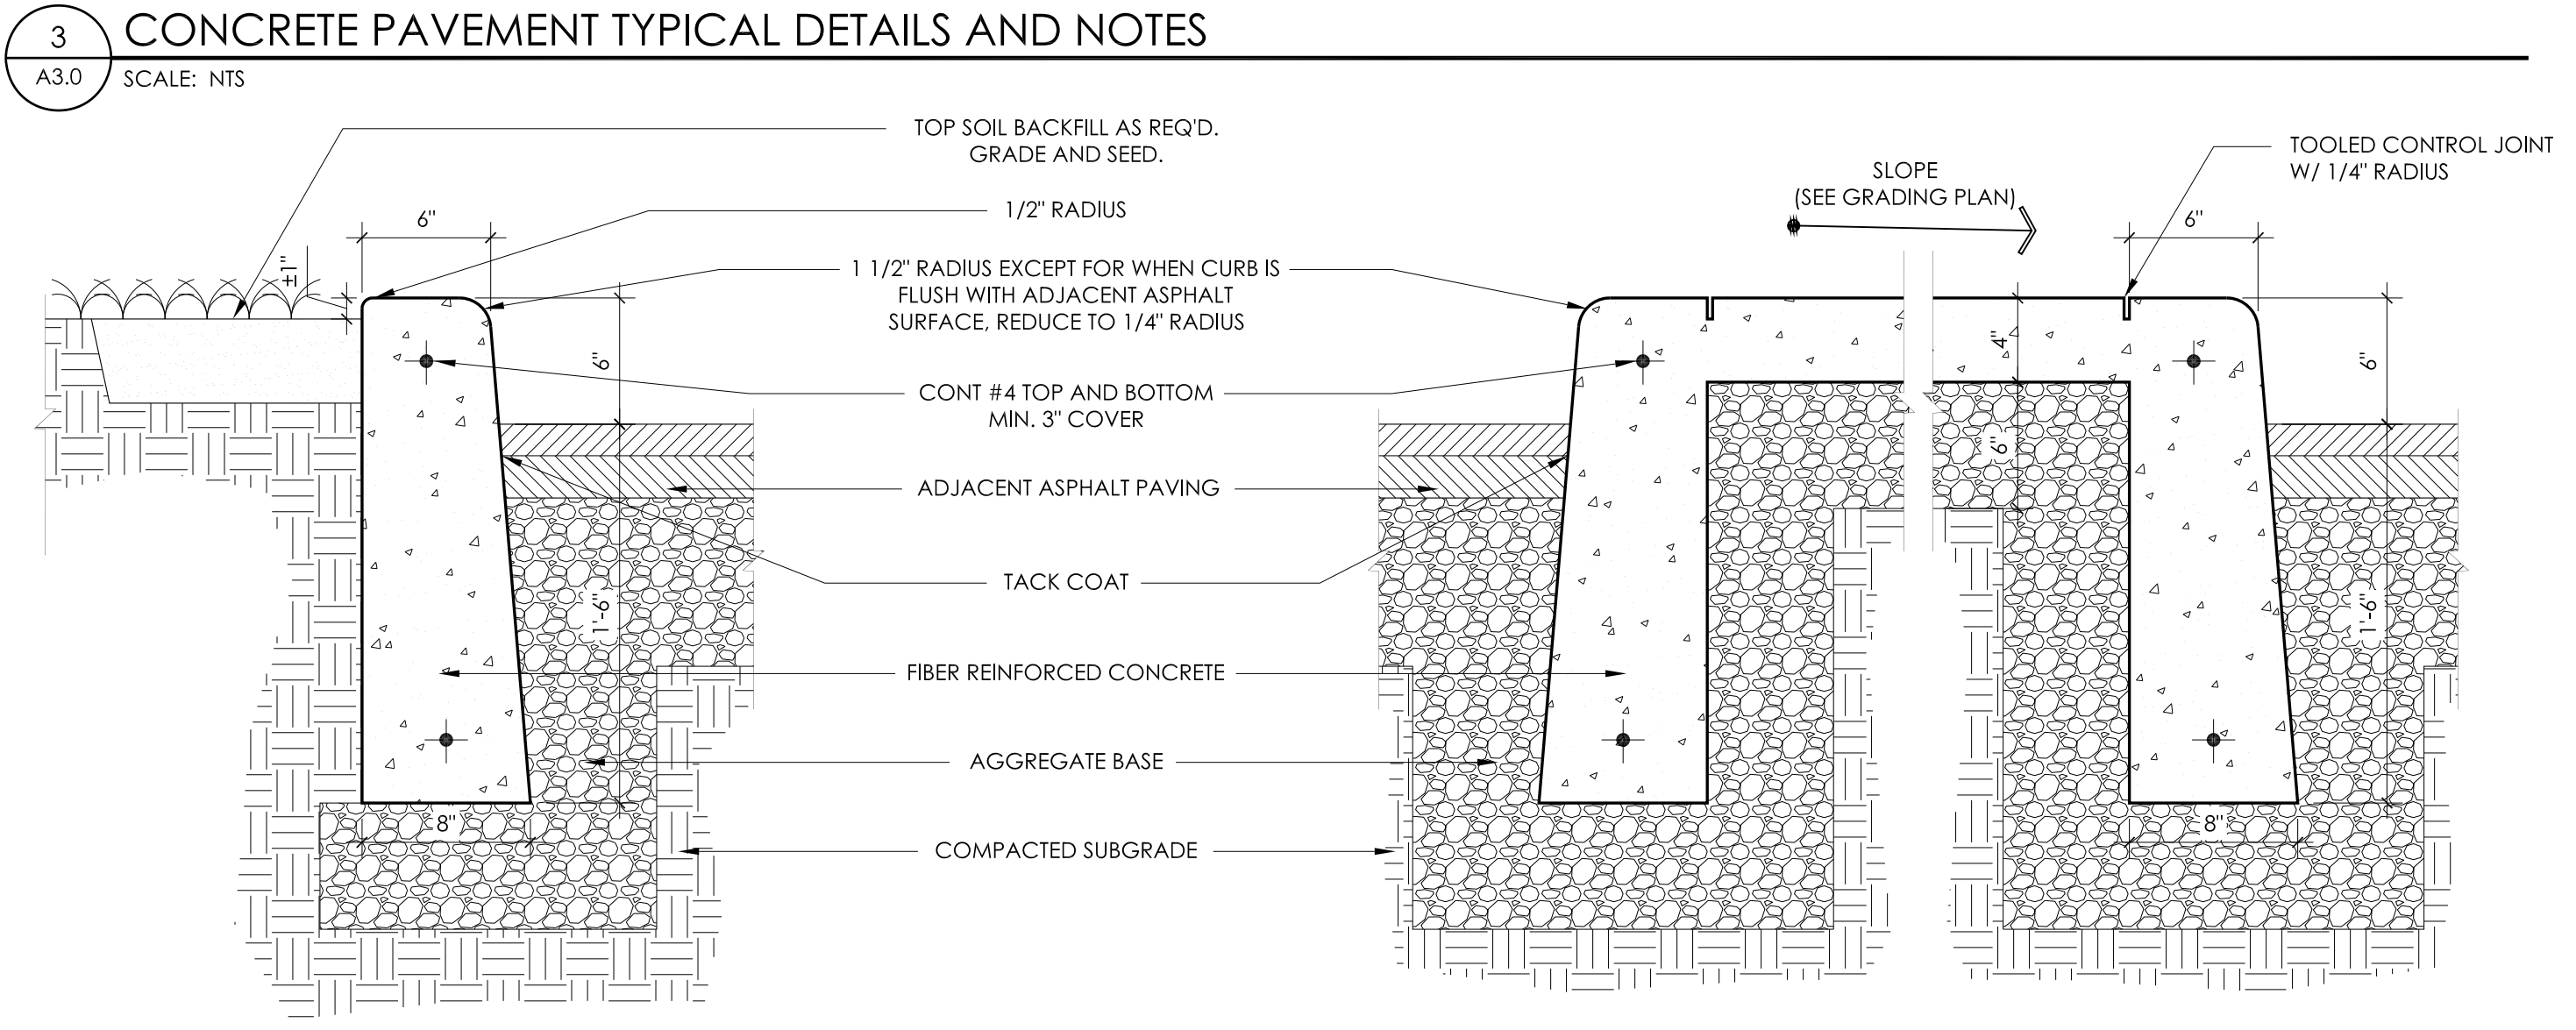


4 CONCRETE CURB
A3.0 SCALE: 1 1/2" = 1' 0"

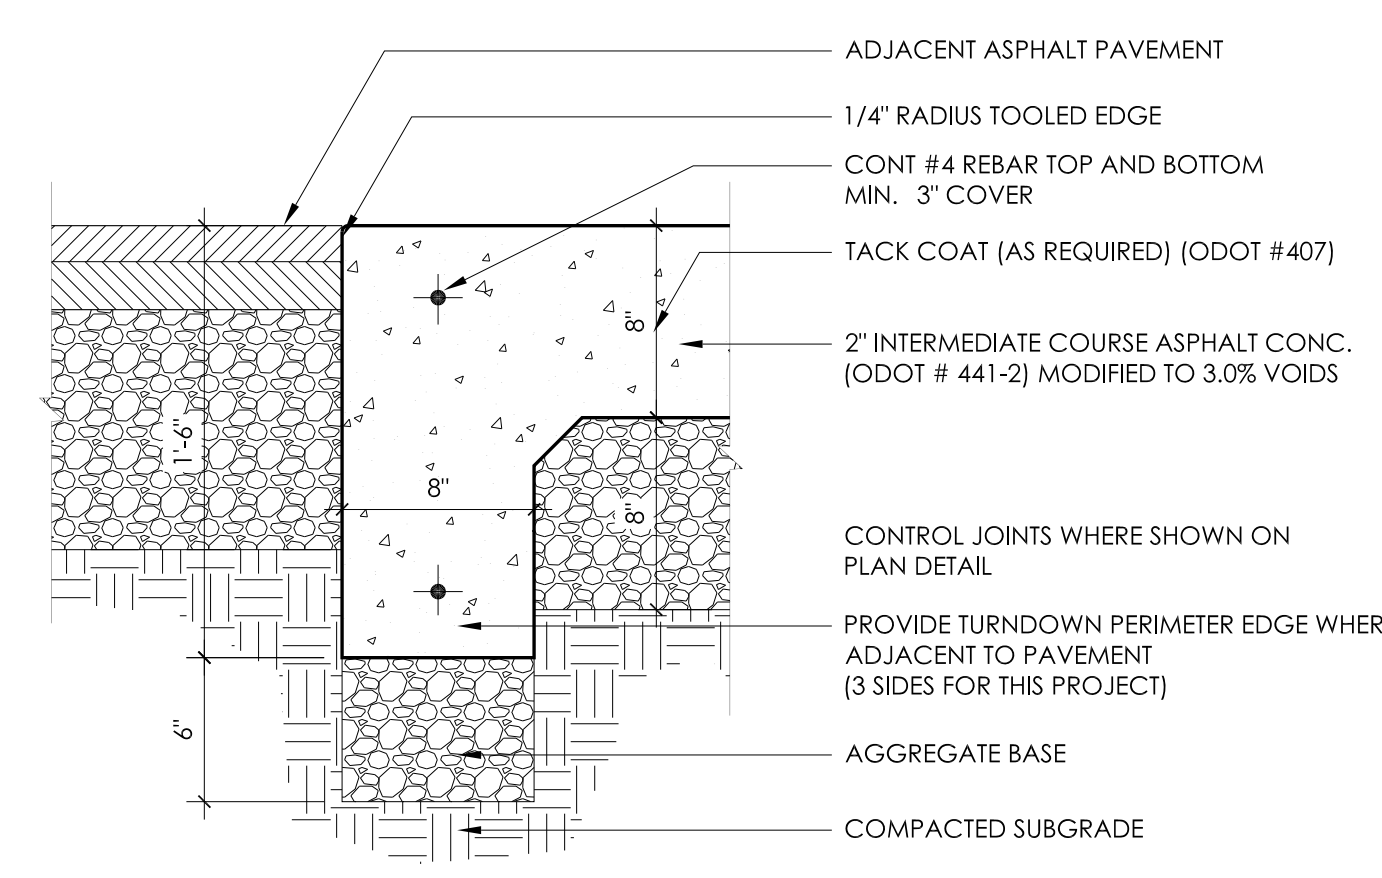


6 CONCRETE DUMPSTER PAD TURNDOWN EDGE
A3.0 SCALE: 1 1/2" = 1' 0" SEE ENLARGED PLAN 6/A3.1 FOR LOCATION

5 CONCRETE SIDEWALK/ISLAND WITH INTEGRAL CURB
A3.0 SCALE: 1 1/2" = 1' 0"

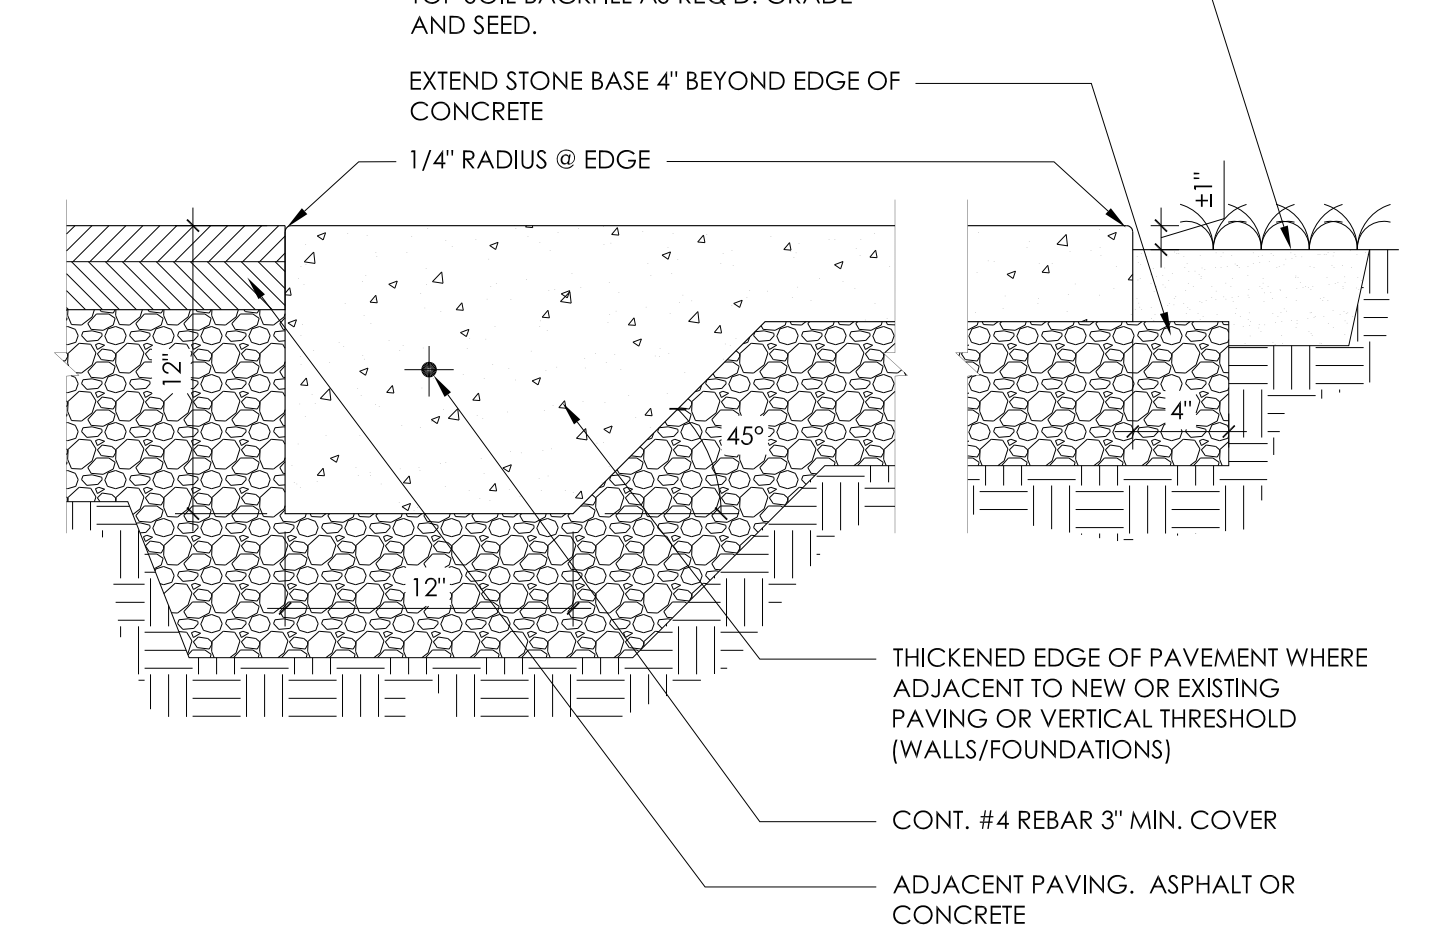

7 TYPICAL STANDARD DUTY CONCRETE SIDEWALK
A3.0 SCALE: 1 1/2" = 1' 0"

CONCRETE CURB @ STREET - WAYNE TRAIL ONLY
A3.0 SCALE: 1 1/2" = 1' 0" SEE ENLARGED PLANS 7/A3.1 AND 8/A3.1 FOR LOCATIONS

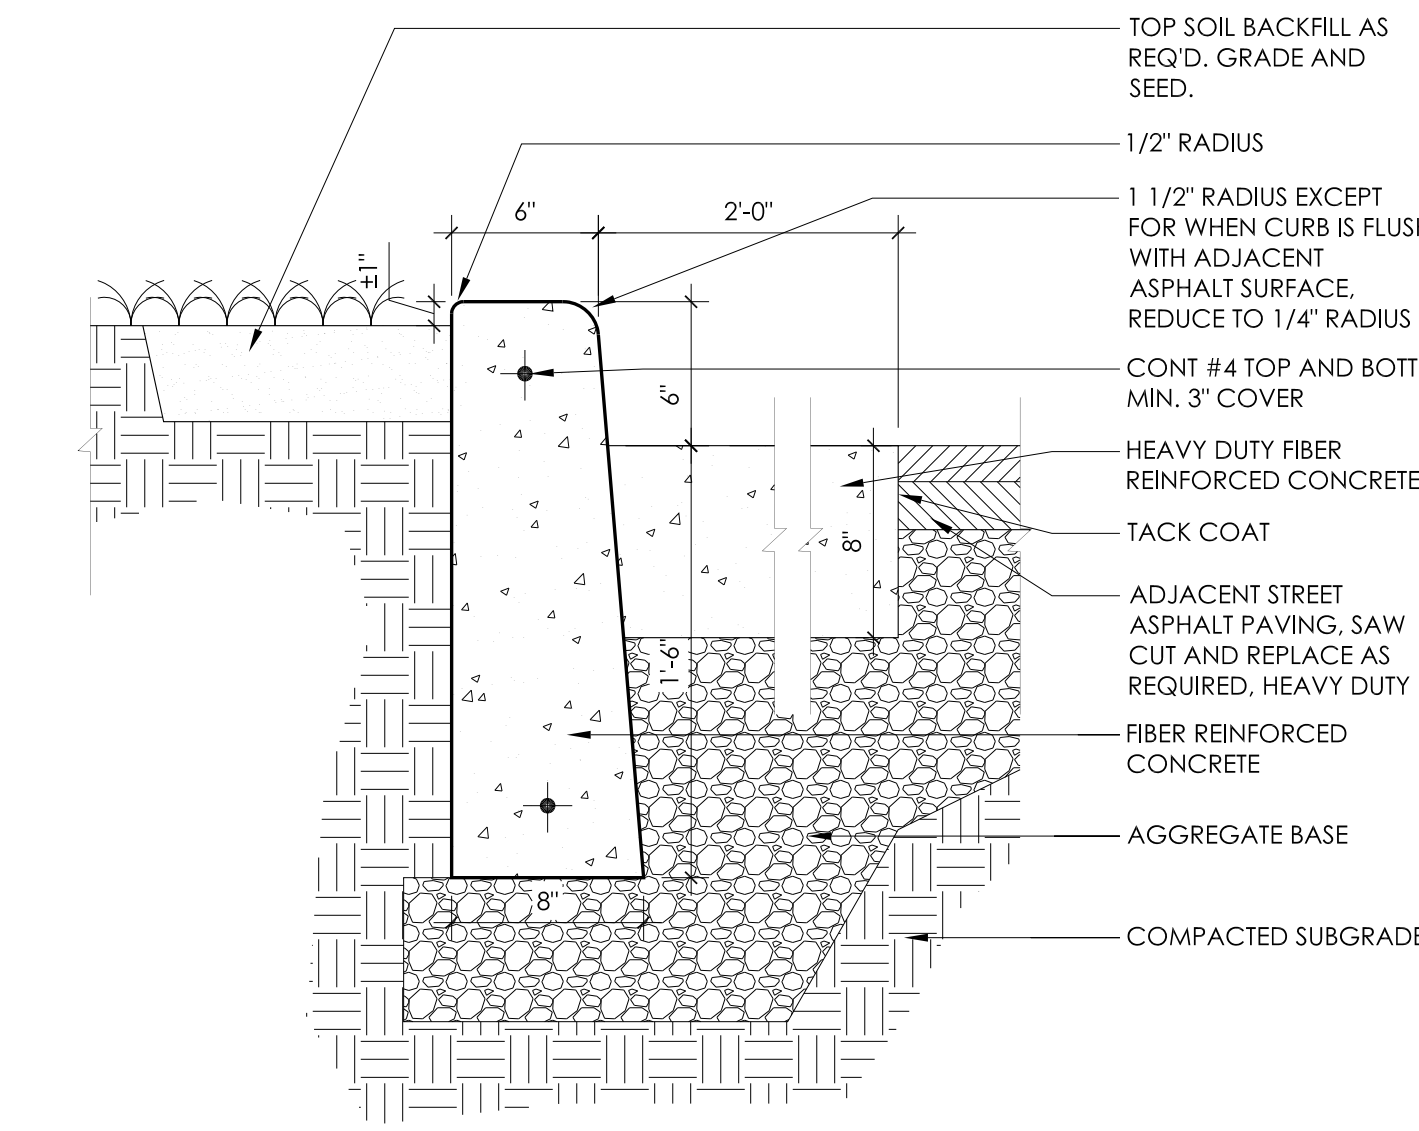

12 CONCRETE CURB @ STREET - WAYNE TRAIL ONLY
A3.0 SCALE: 1 1/2" = 1' 0" SEE ENLARGED PLANS 7/A3.1 AND 8/A3.1 FOR LOCATIONS

THOMAS
PORTER
ARCHITECTS

8 North St. Clair - Toledo, Ohio 43604-1028
T 419.243.2400
www.thomasporterarchitects.com

CONSULTANTS:

Engineers, Surveyors & Associates, LLC
5353 Secor Rd., Toledo, Ohio 43623 Phone (419) 475-9445

Seal of Andrew R. Knopp, Registered Architect, License #1817352, Exp. Date 12/31/2021

SUMMER PAVING PROJECTS
MAUMEE CITY SCHOOLS

WAYNE TRAIL ELEMENTARY
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FAIRFIELD ELEMENTARY
1313 EASTFIELD ROAD
MAUMEE, OHIO 43537

PROJECT TITLE:

ISSUE OR REVISION:

DATE	ISSUE / REVISION
03.05.2020	BID DOCUMENTS


DESIGNED: ACH
DRAWN: ACH
CHECKED: JEA

TPA COMMISSION NUMBER: 19060

DRAWING TITLE:


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A3.0

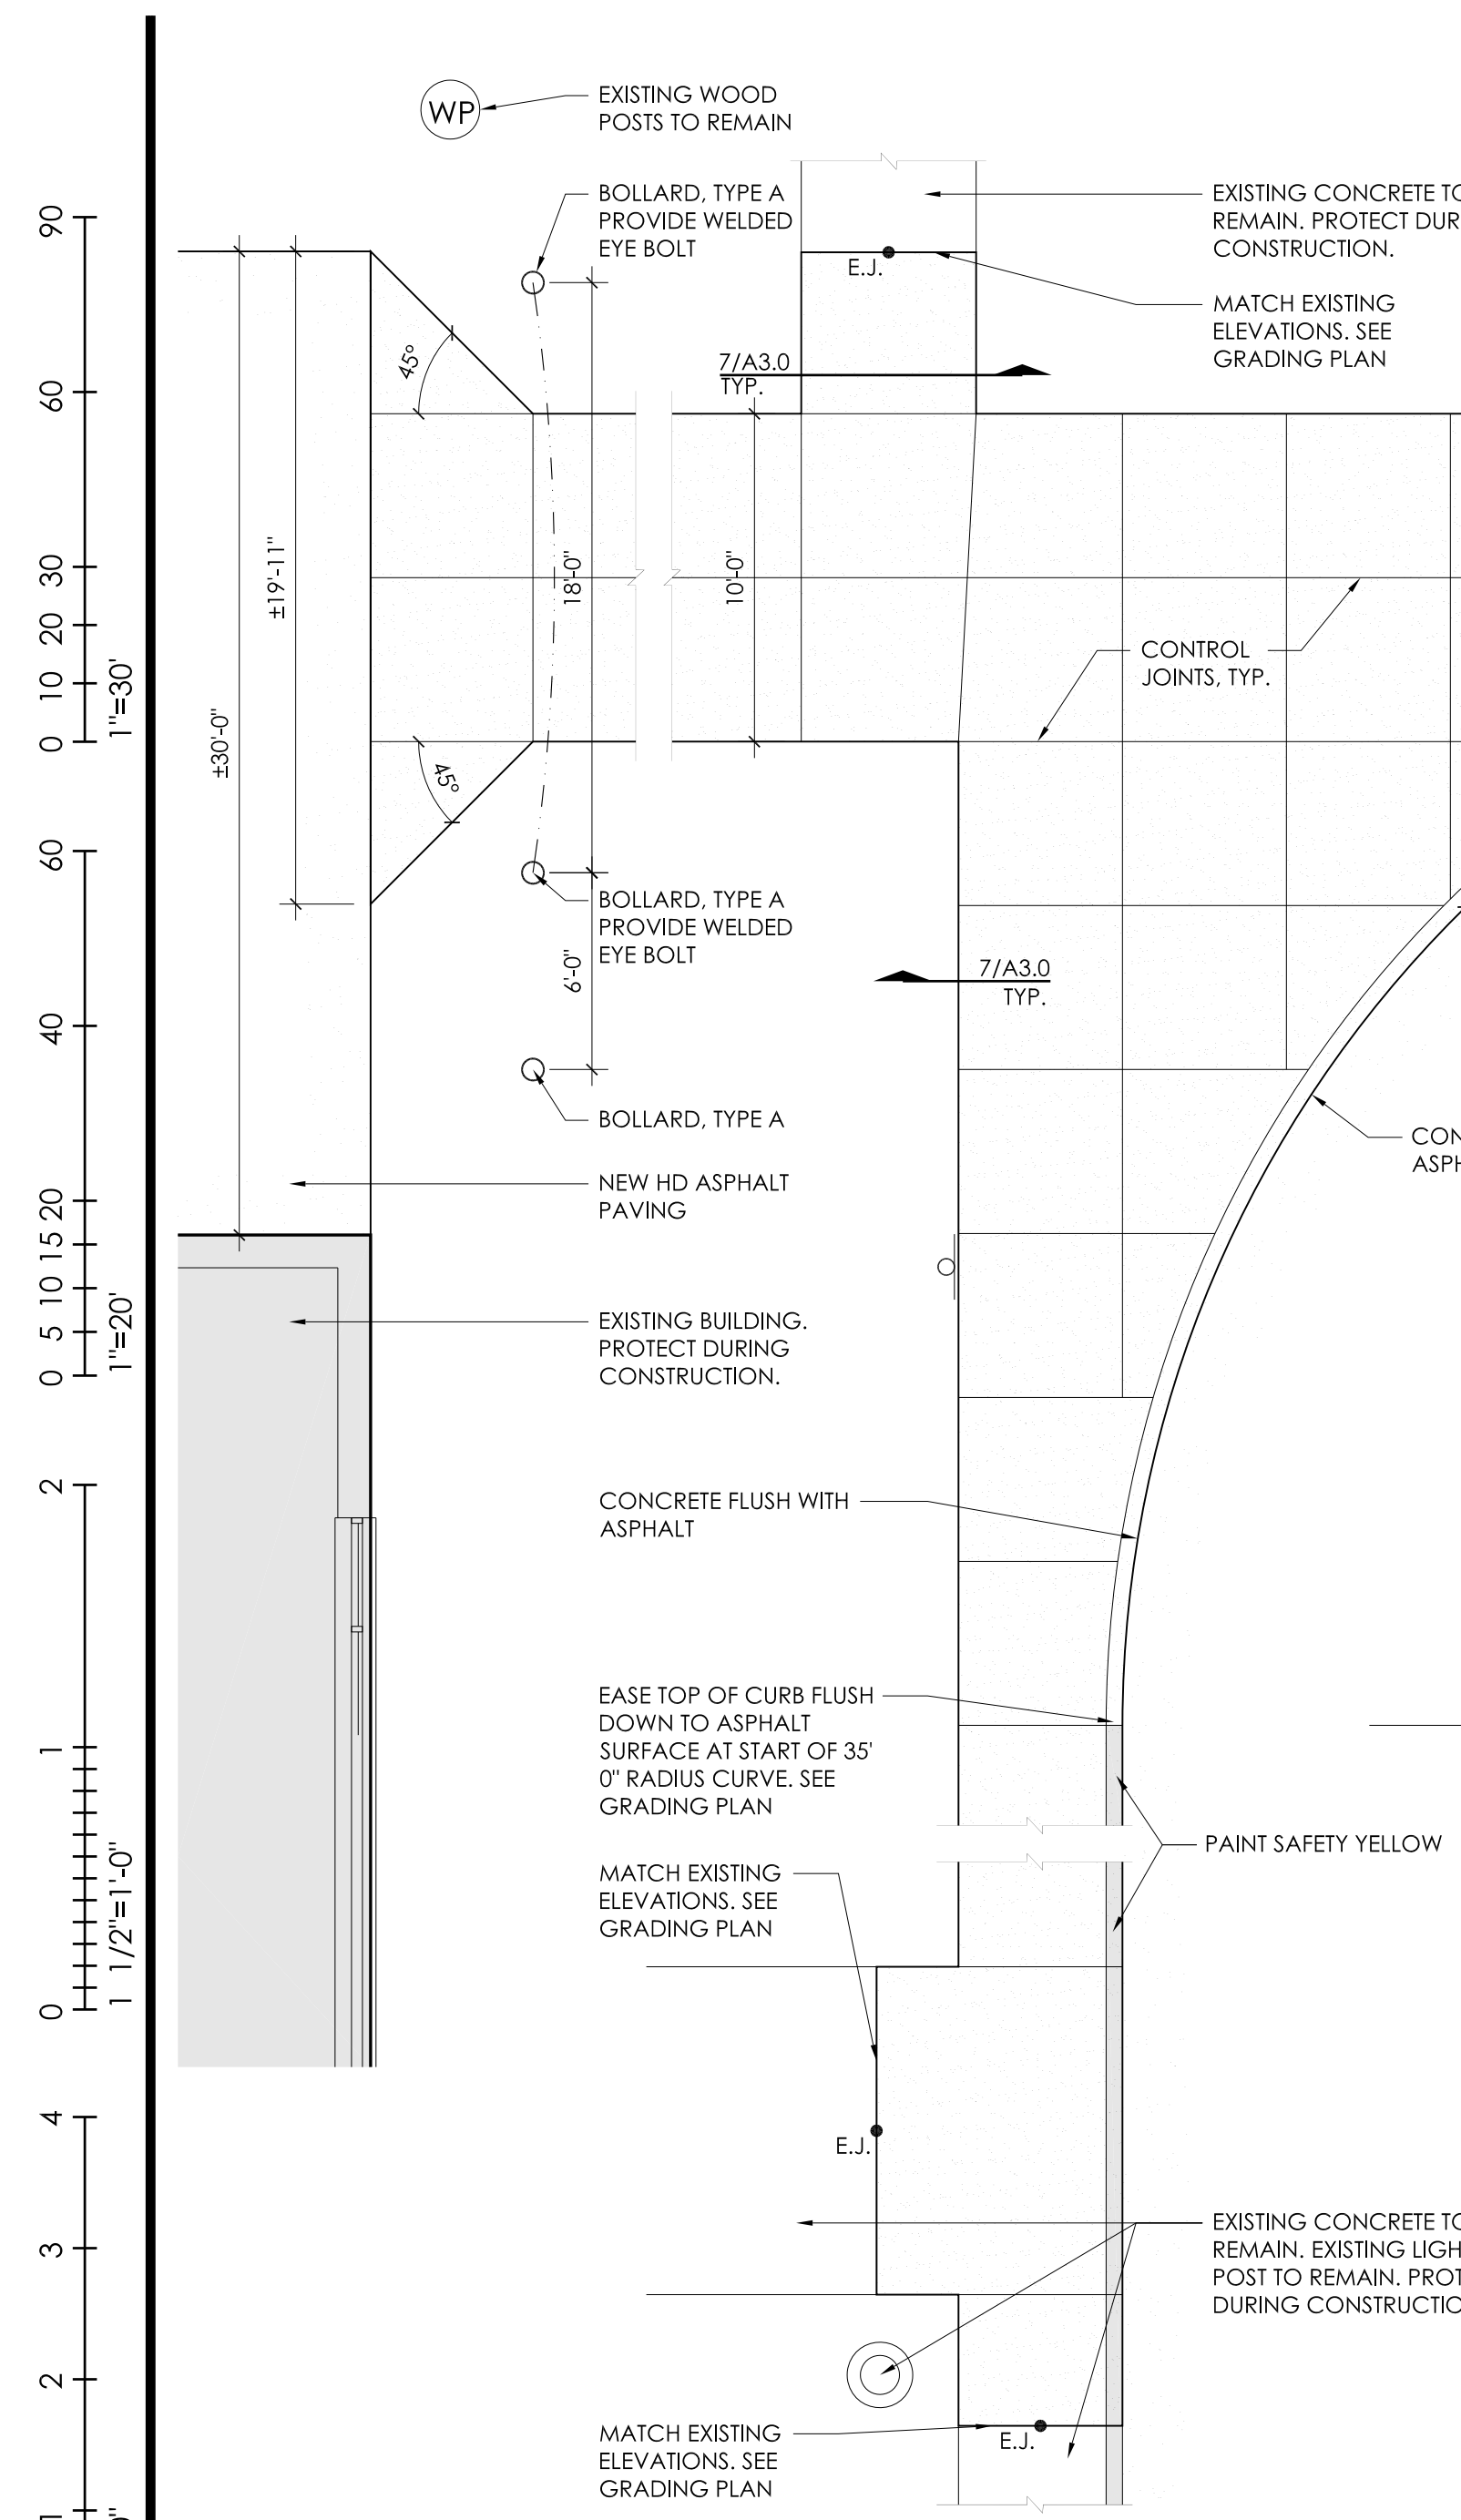


1 ENLARGED PLAN

A3.1 3/16" = 1'-0"

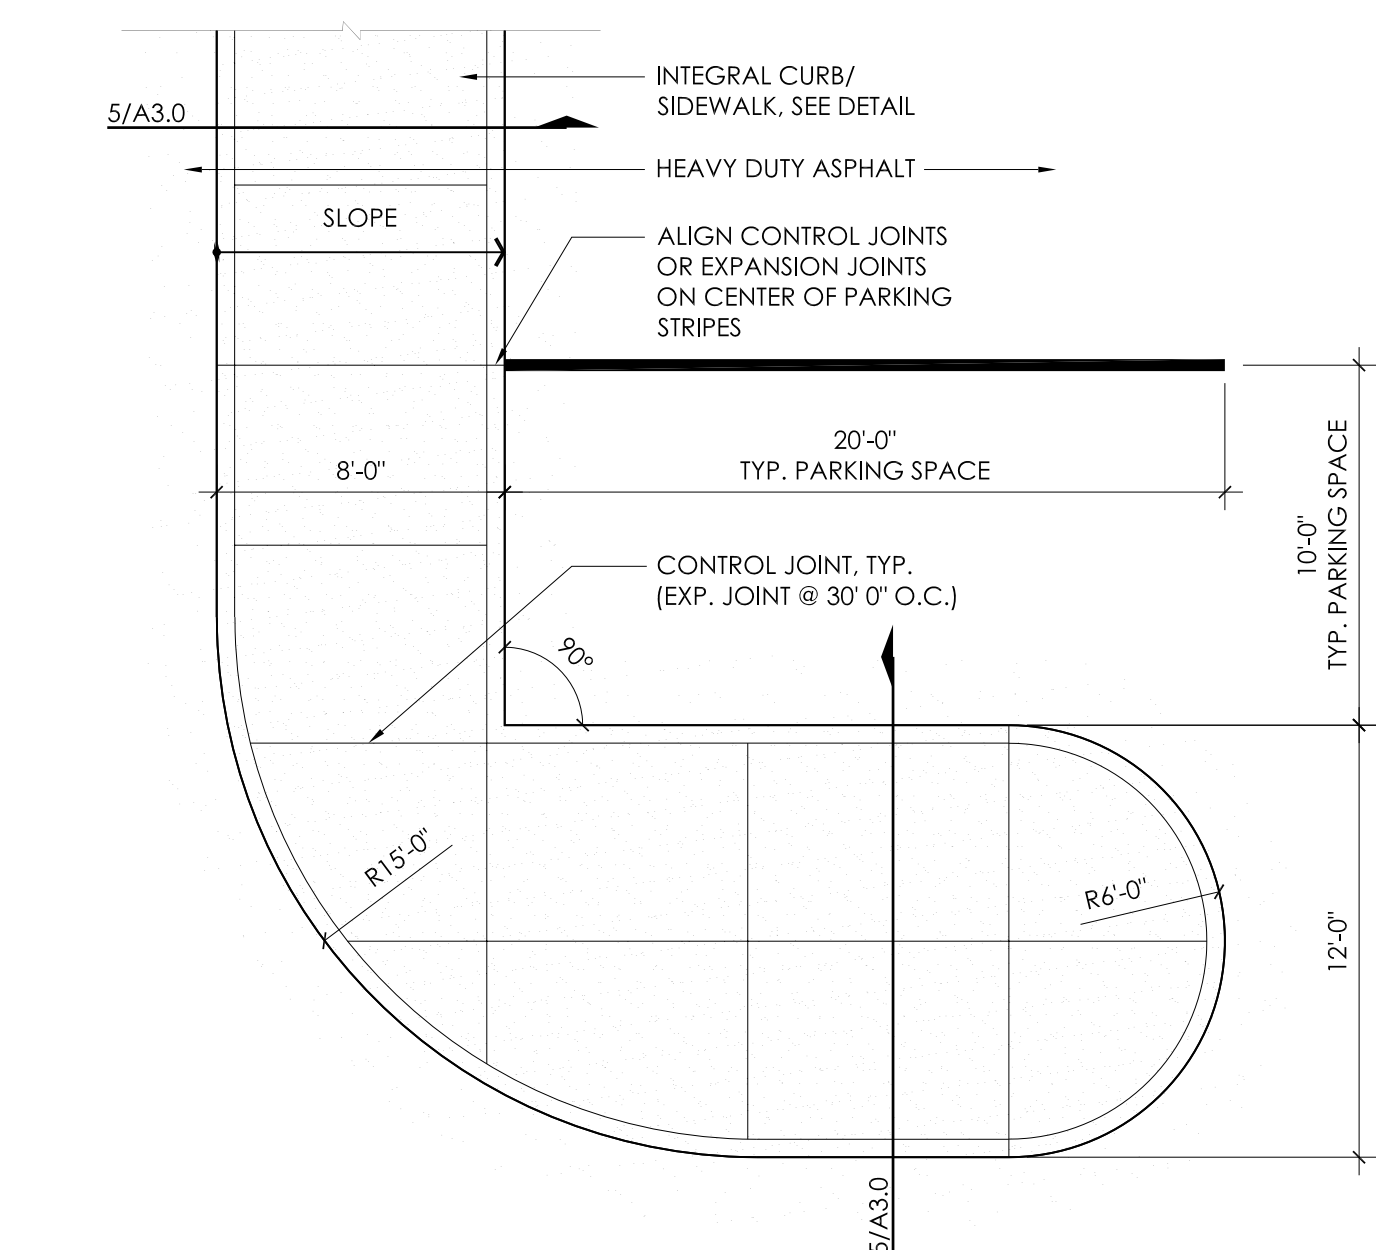


2 ENLARGED PLAN - CONCRETE ISLAND

A3.1 3/16" = 1'-0"

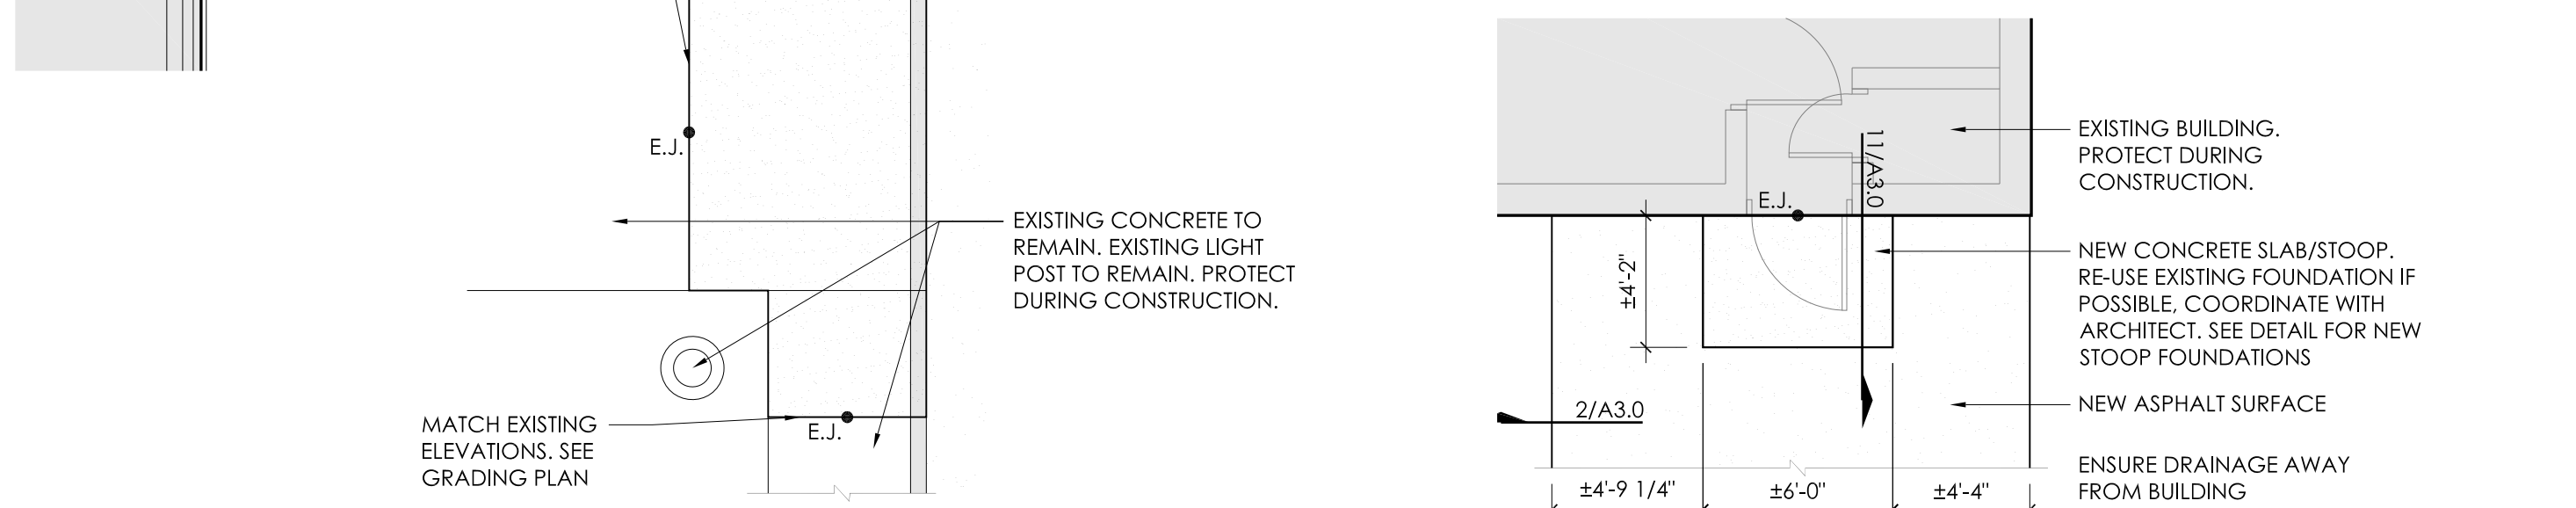


3 ENLARGED PLAN - CONCRETE STOOP

A3.1 3/16" = 1'-0"

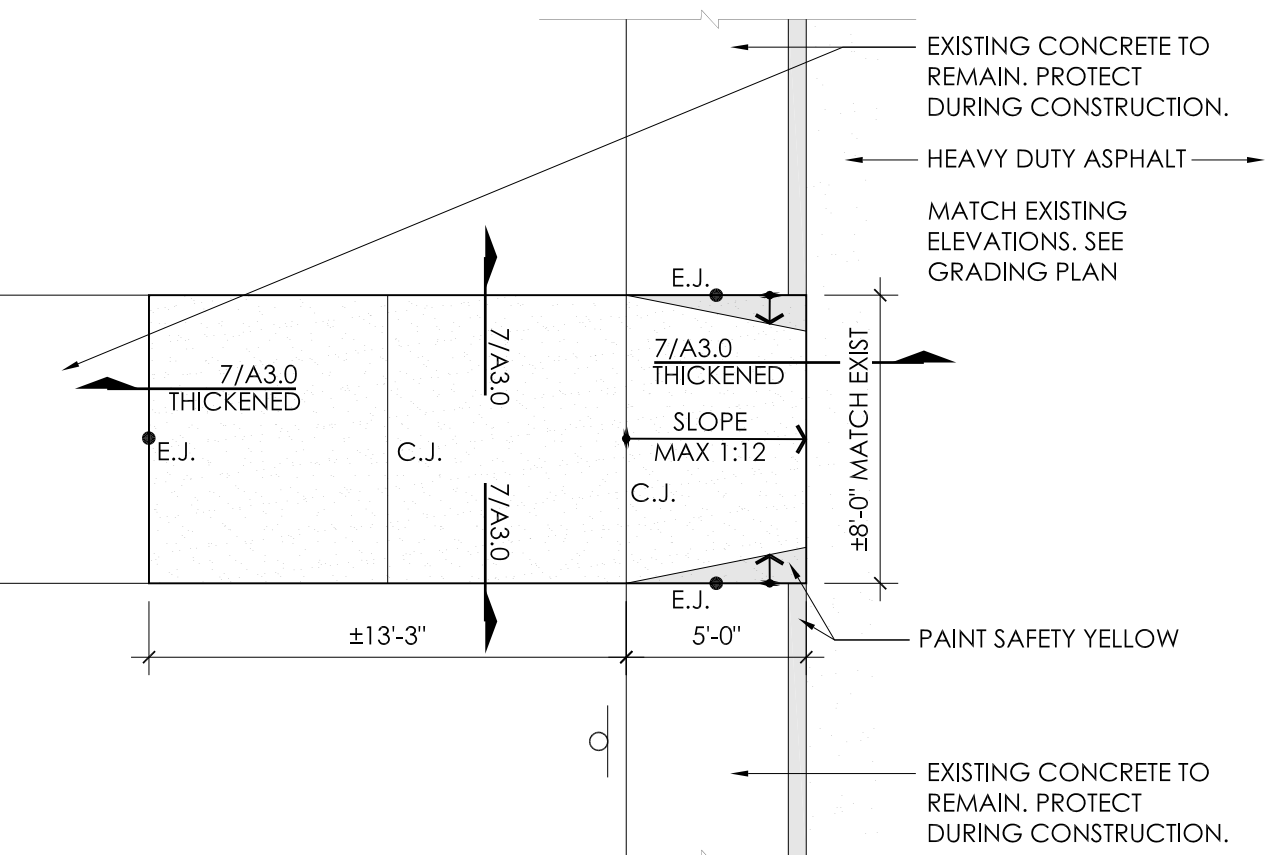


4 ENLARGED PLAN - CONCRETE SIDEWALK REPLACEMENT

A3.1 3/16" = 1'-0"

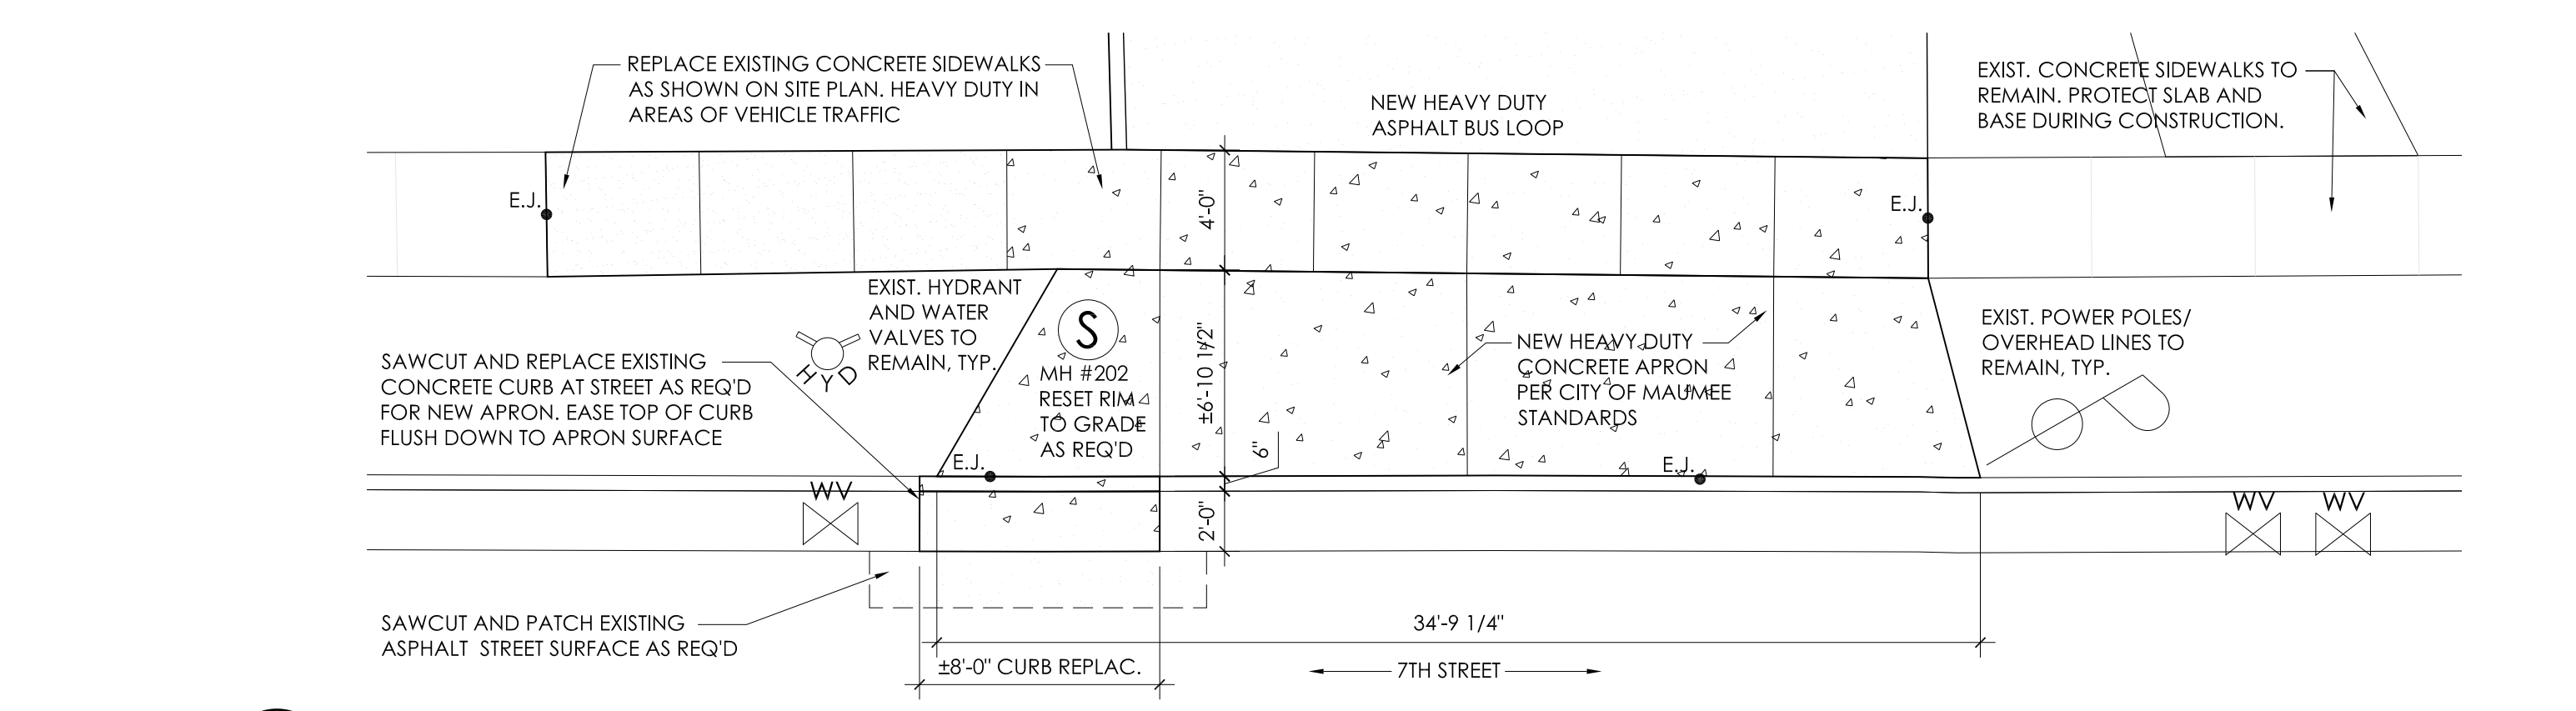


7 ENLARGED PLAN - CONCRETE APRON - WAYNE TRAIL ENTRY

A3.1 3/16" = 1'-0"

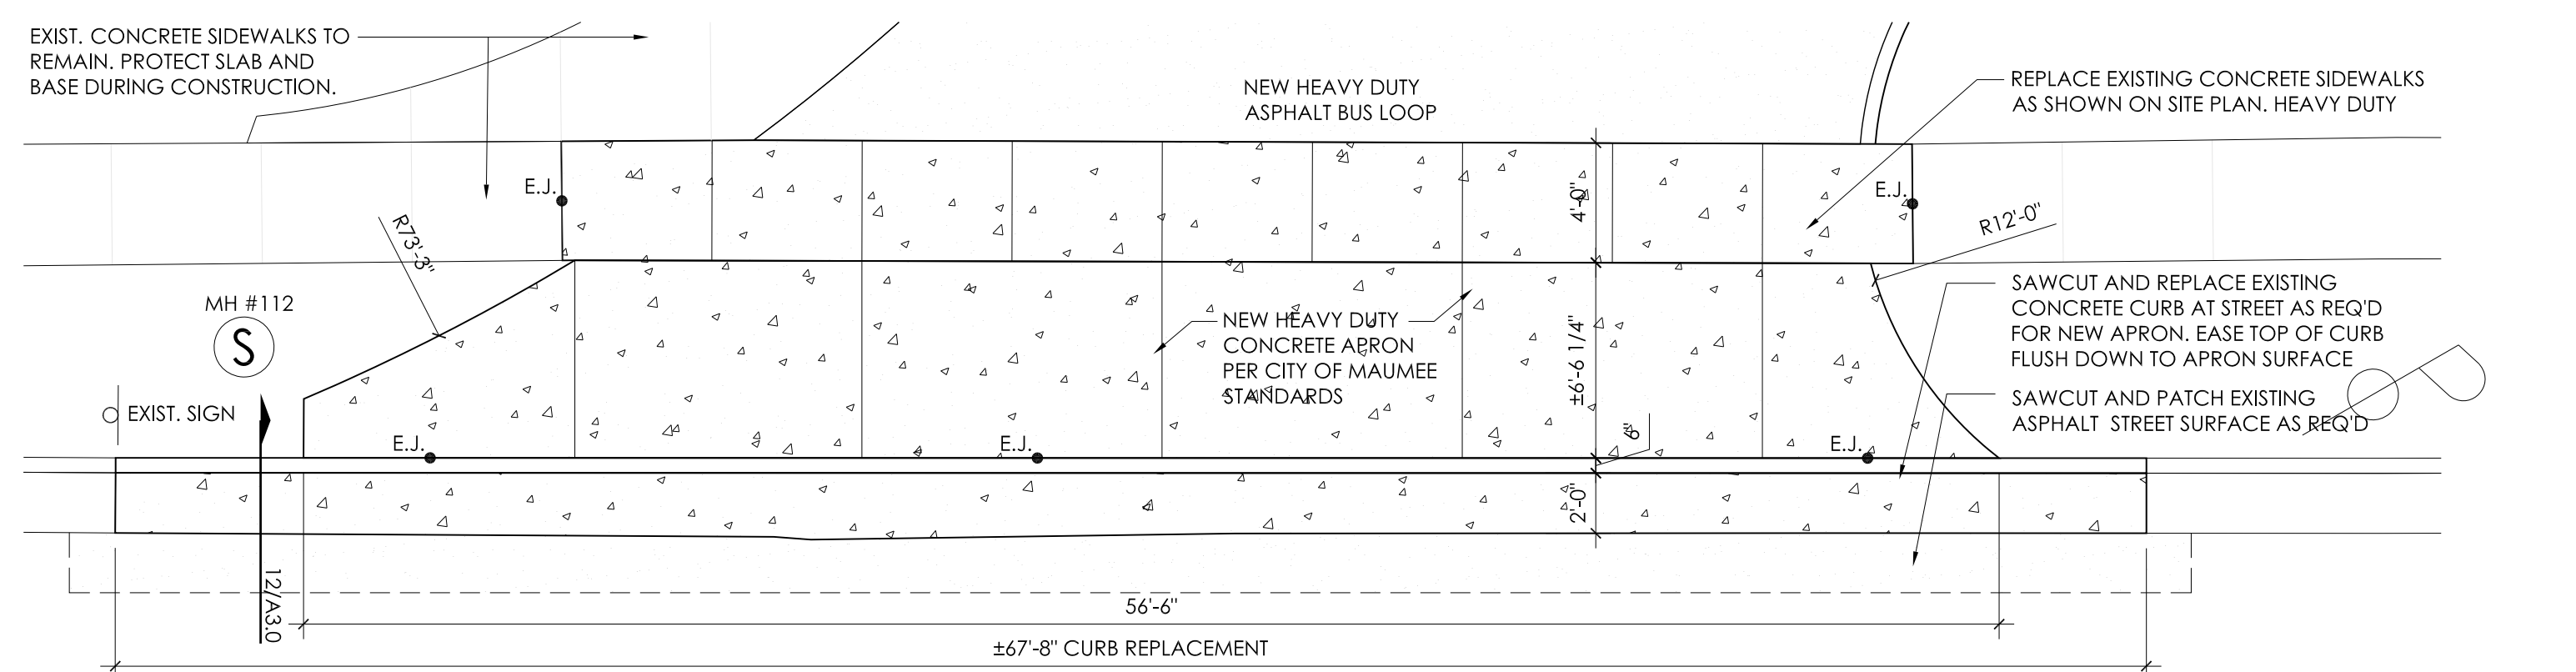


8 ENLARGED PLAN - CONCRETE APRON - WAYNE TRAIL EXIT

A3.1 3/16" = 1'-0"

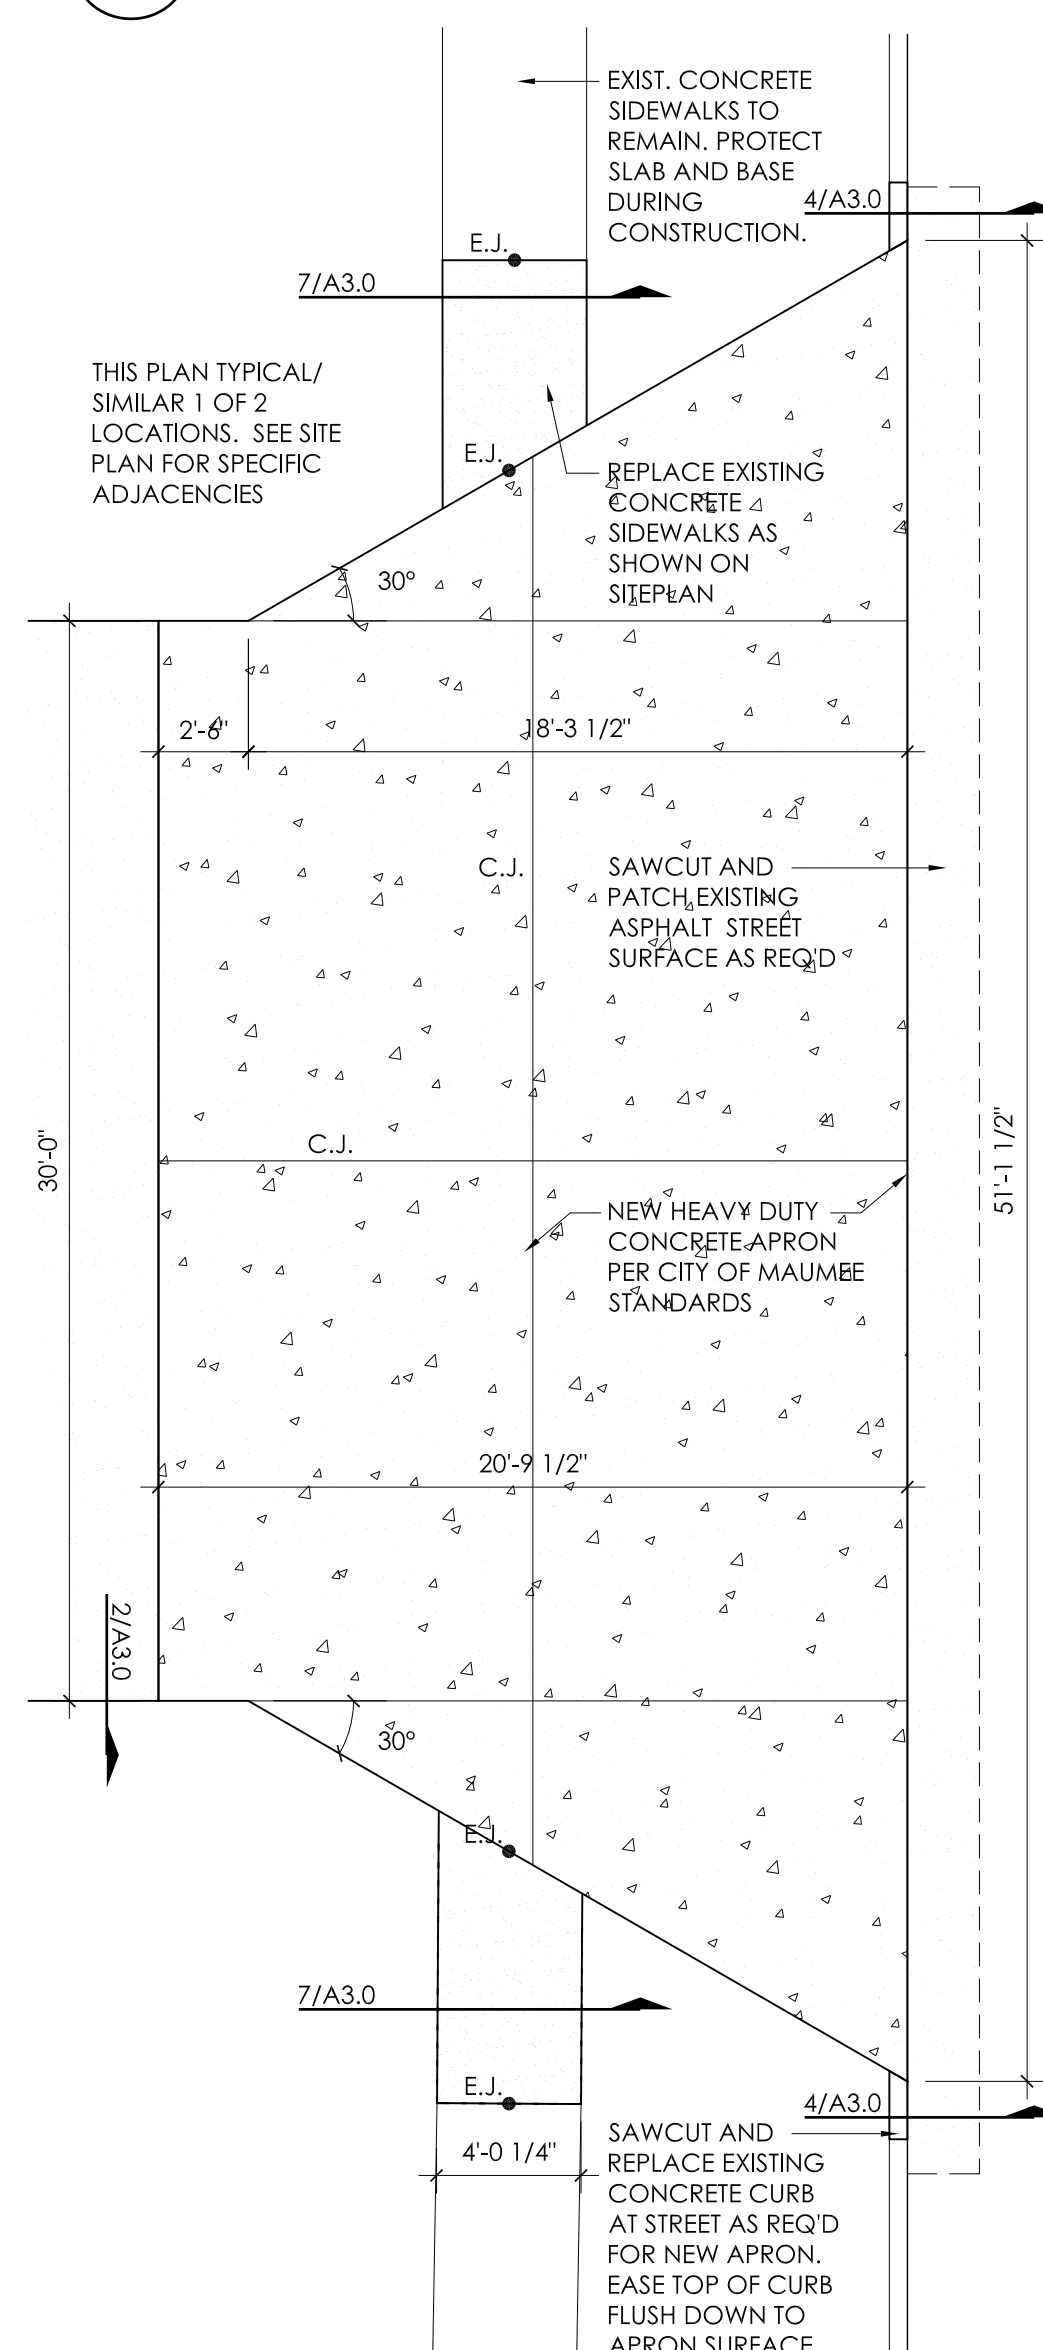


5 ENLARGED PLAN - CONCRETE APRON

A3.1 3/16" = 1'-0"

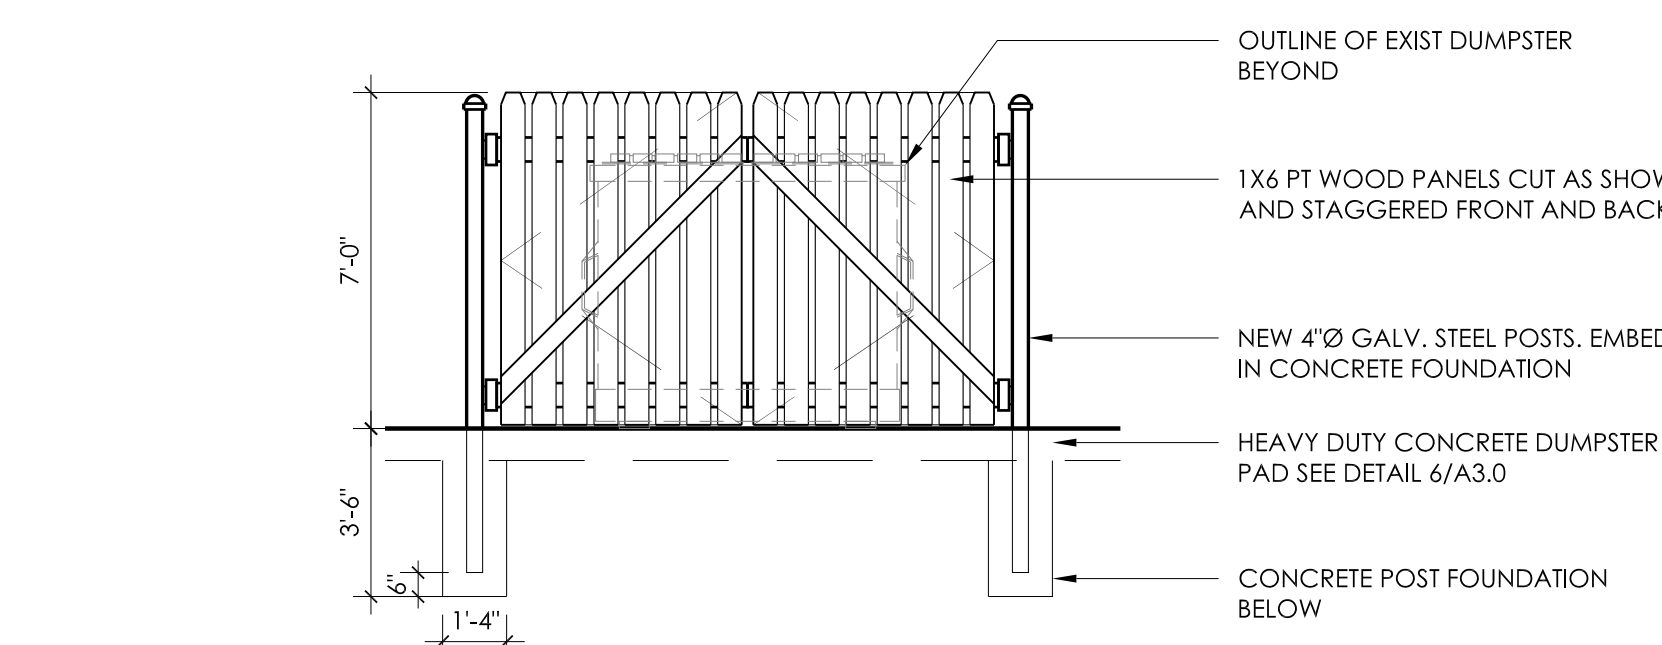

6.1 DUMBSTER ENCLOSURE ELEVATION


A3.1 1/4" = 1'-0"

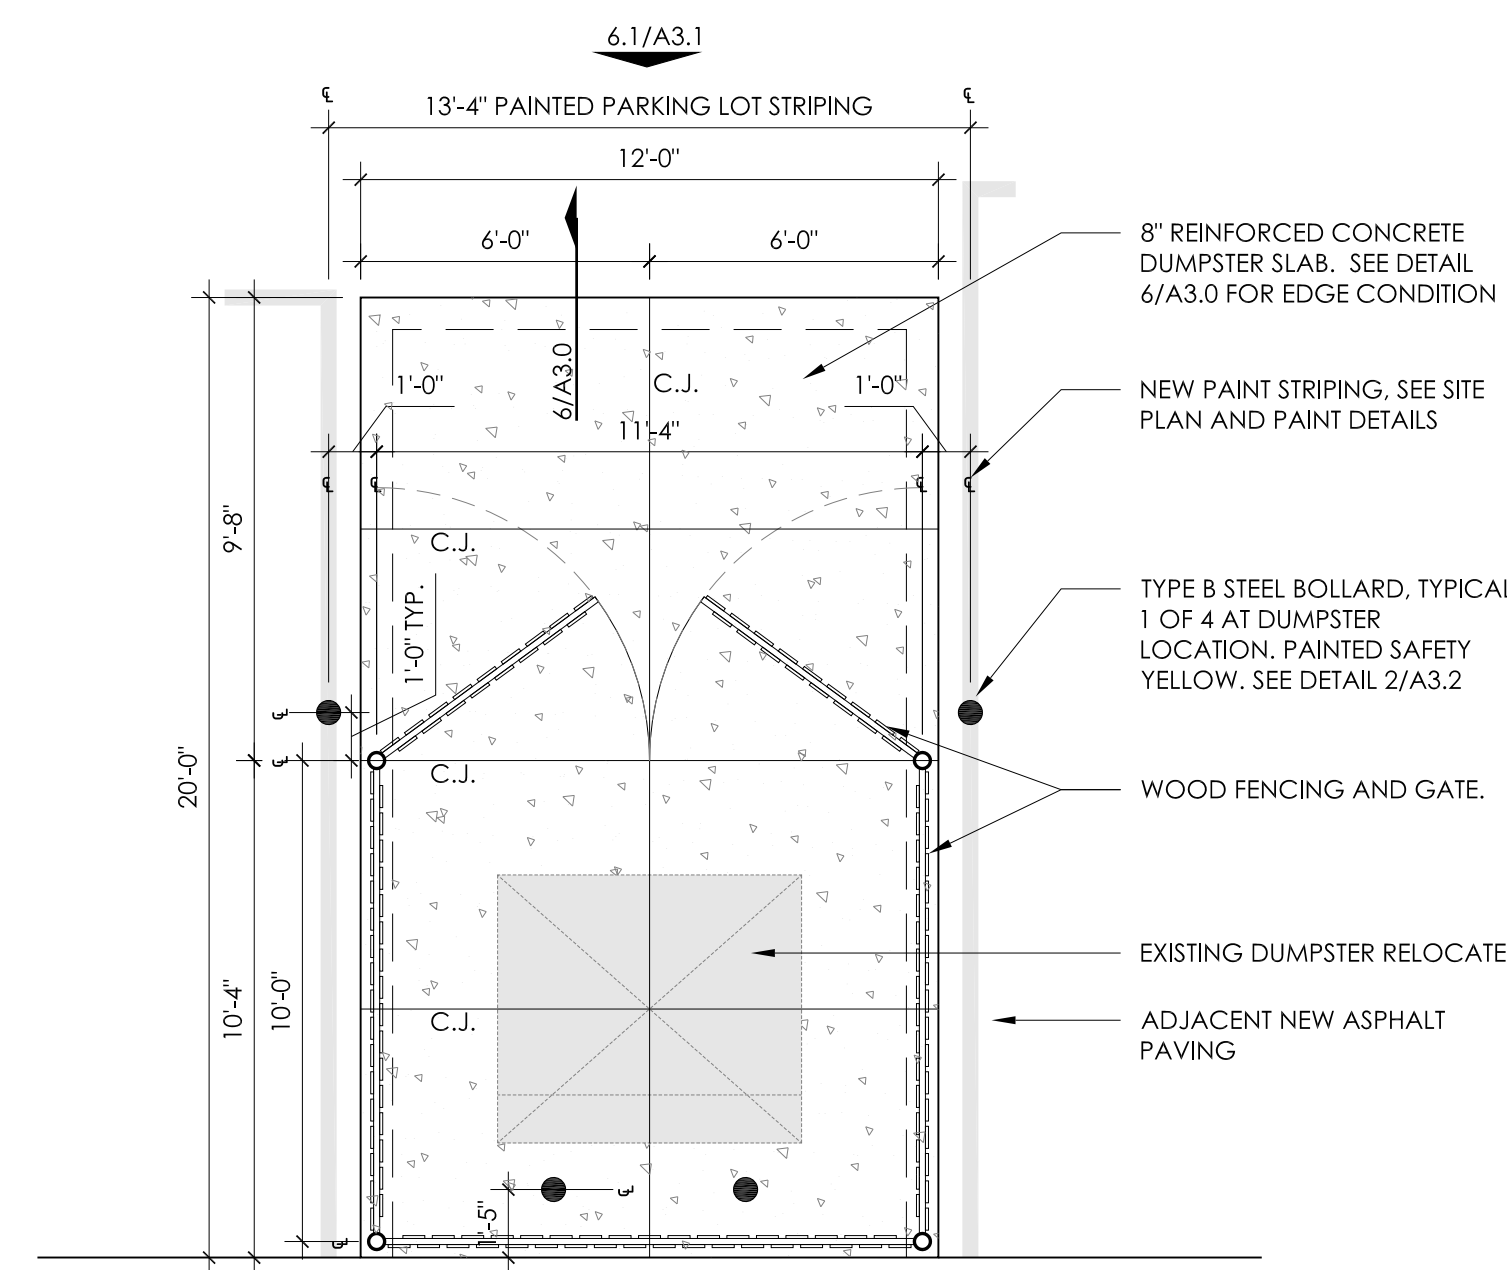


6 ENLARGED DUMPSTER ENCLOSURE PLAN

A3.1 1/4" = 1'-0"


90
60
30
0 10 20 30
1"=30"
60
40
20
0 5 10 15 20
1"=20"
2
1
0
1 1/2"=1'-0"
4
3
2
1
0
1
3/4"=1'-0"
6
5
4
3
2
1
0
1
2
3
4
5
6
7
8
0 1 2 3 4 5 6 7 8
3/8"=1'-0"

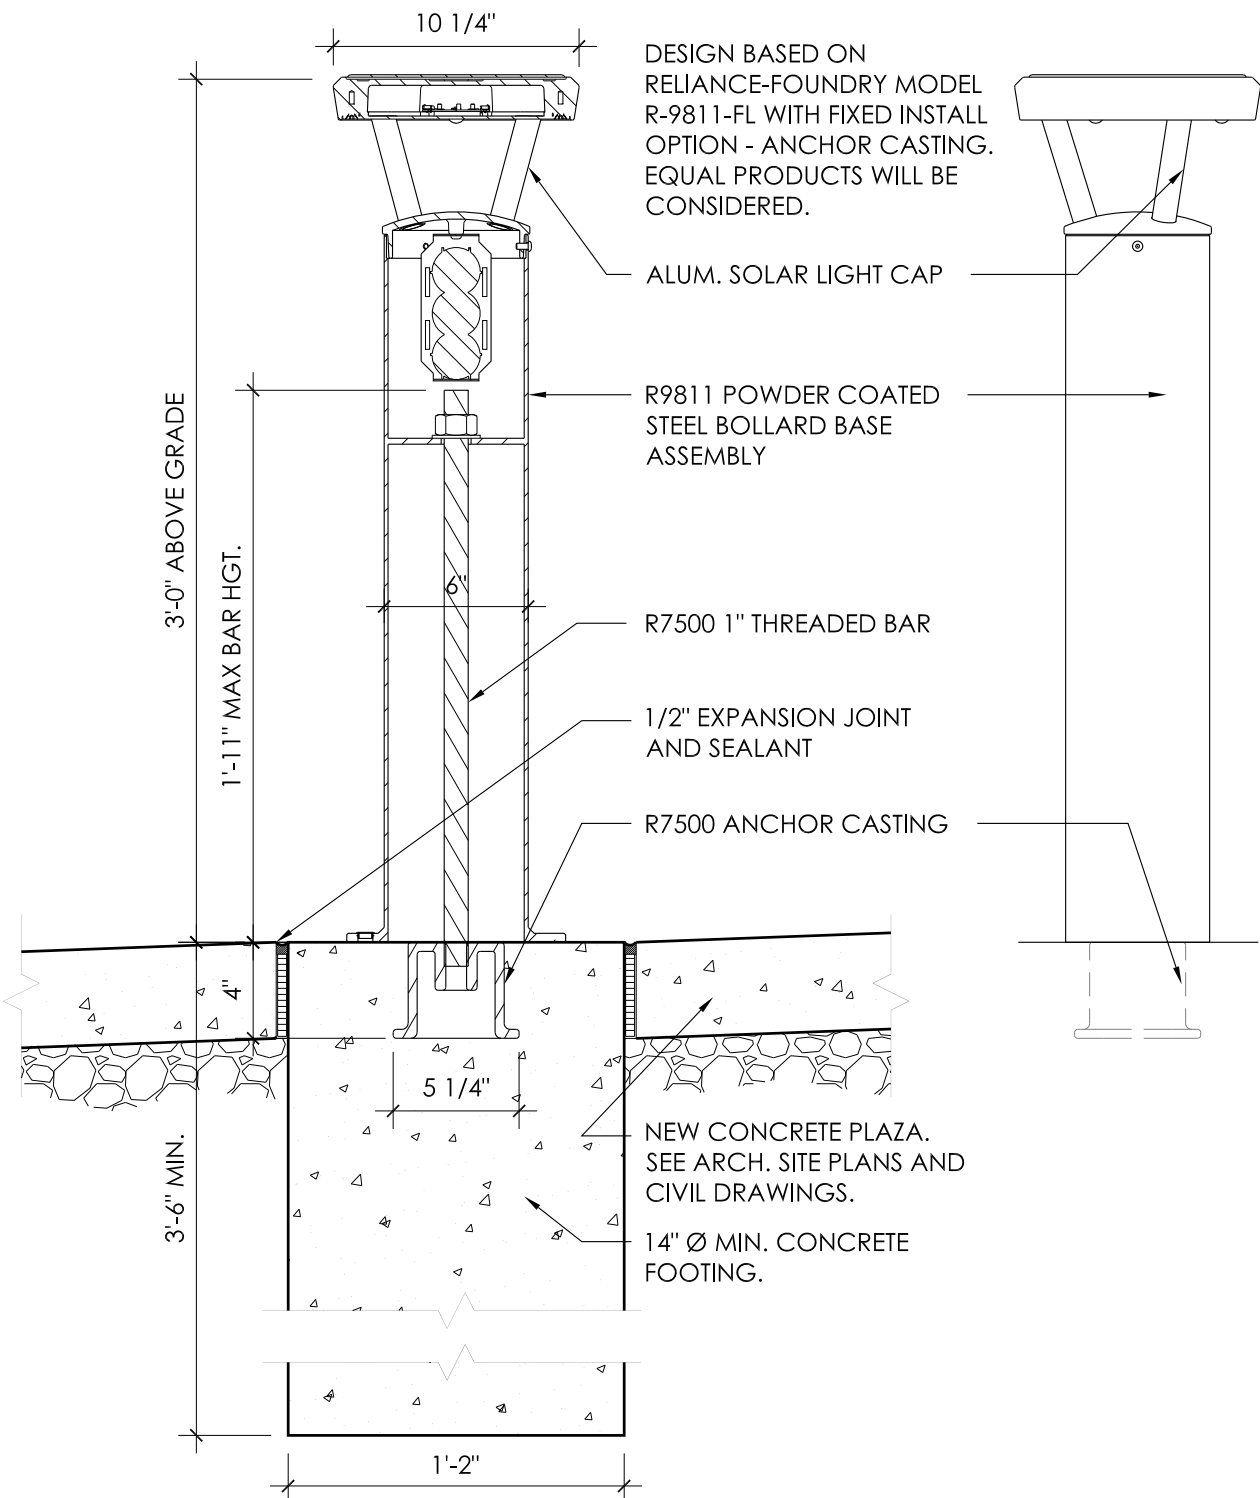


1 FIXED BOLLARD DETAIL - TYPE A
A3.2 SCALE: 1 1/2" = 1'-0"

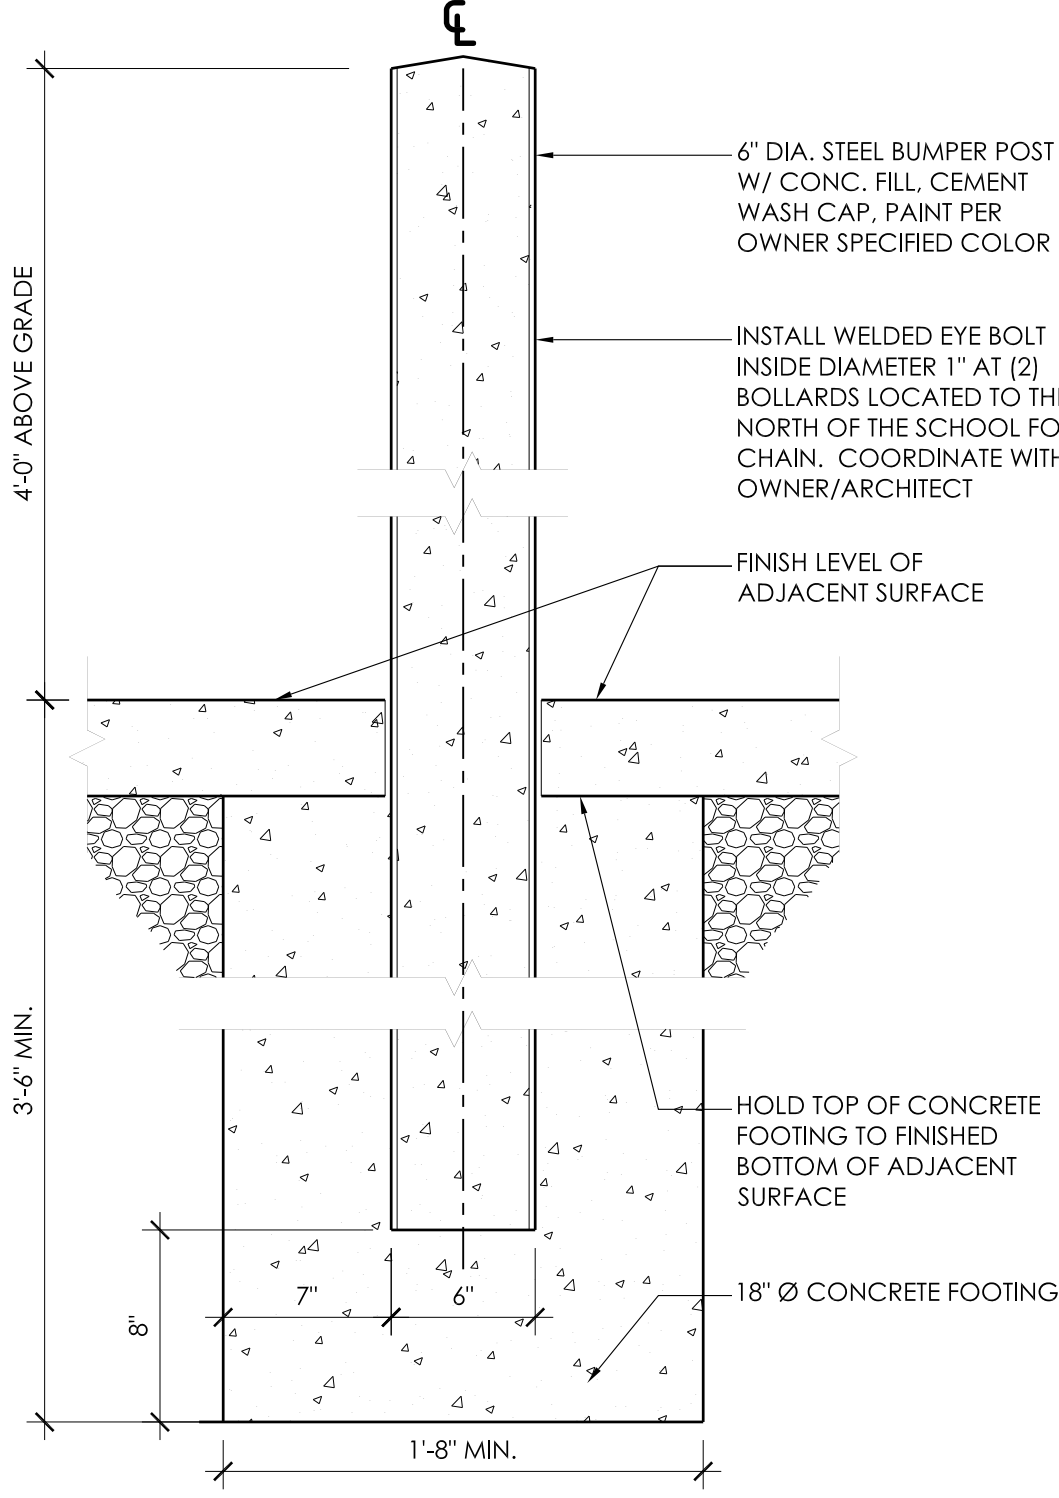


2 FIXED BOLLARD DETAIL - TYPE B
A3.2 SCALE: 1 1/2" = 1'-0"

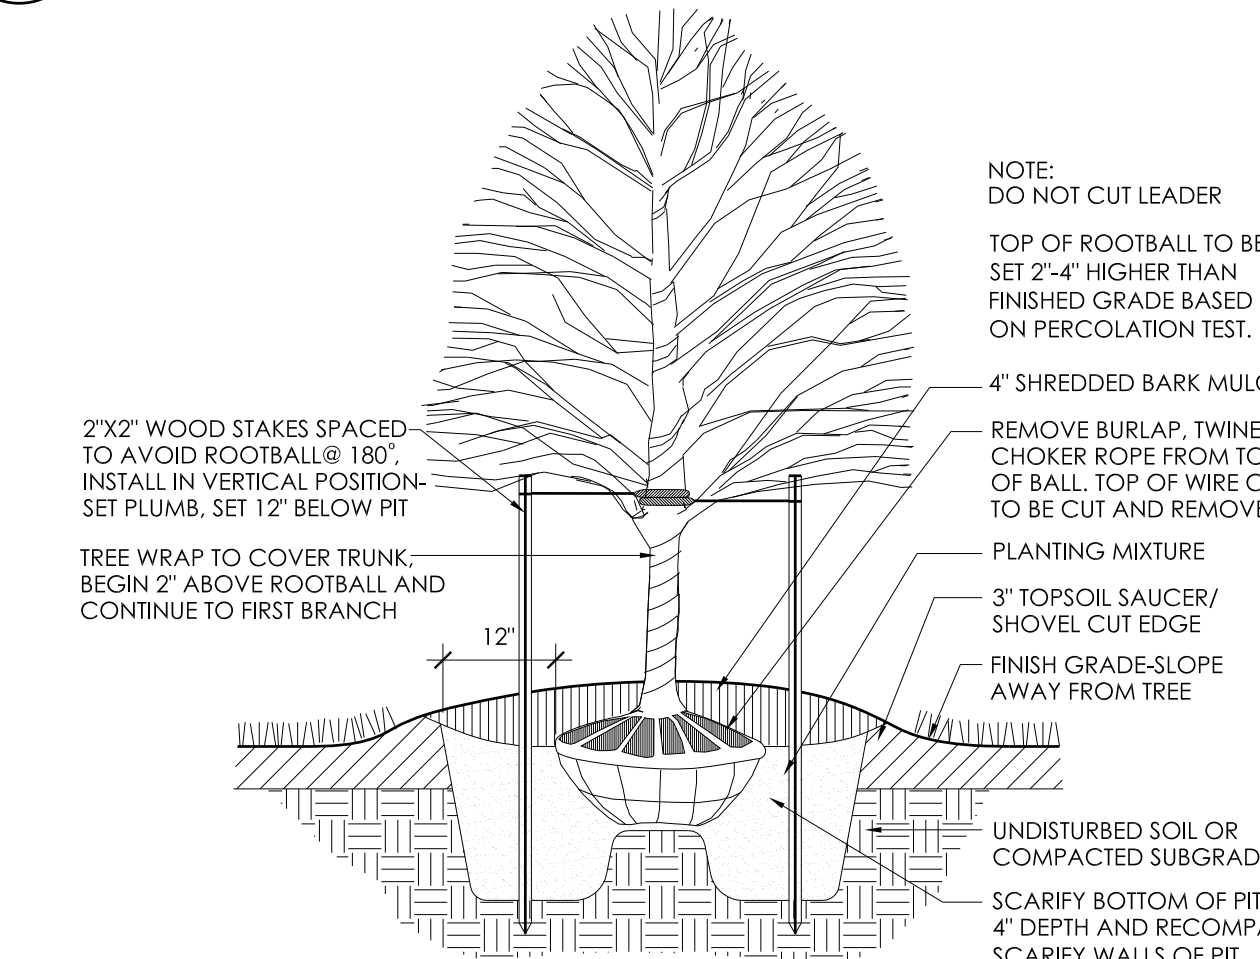


5 TREE PLANTING DETAIL
A3.2 NTS

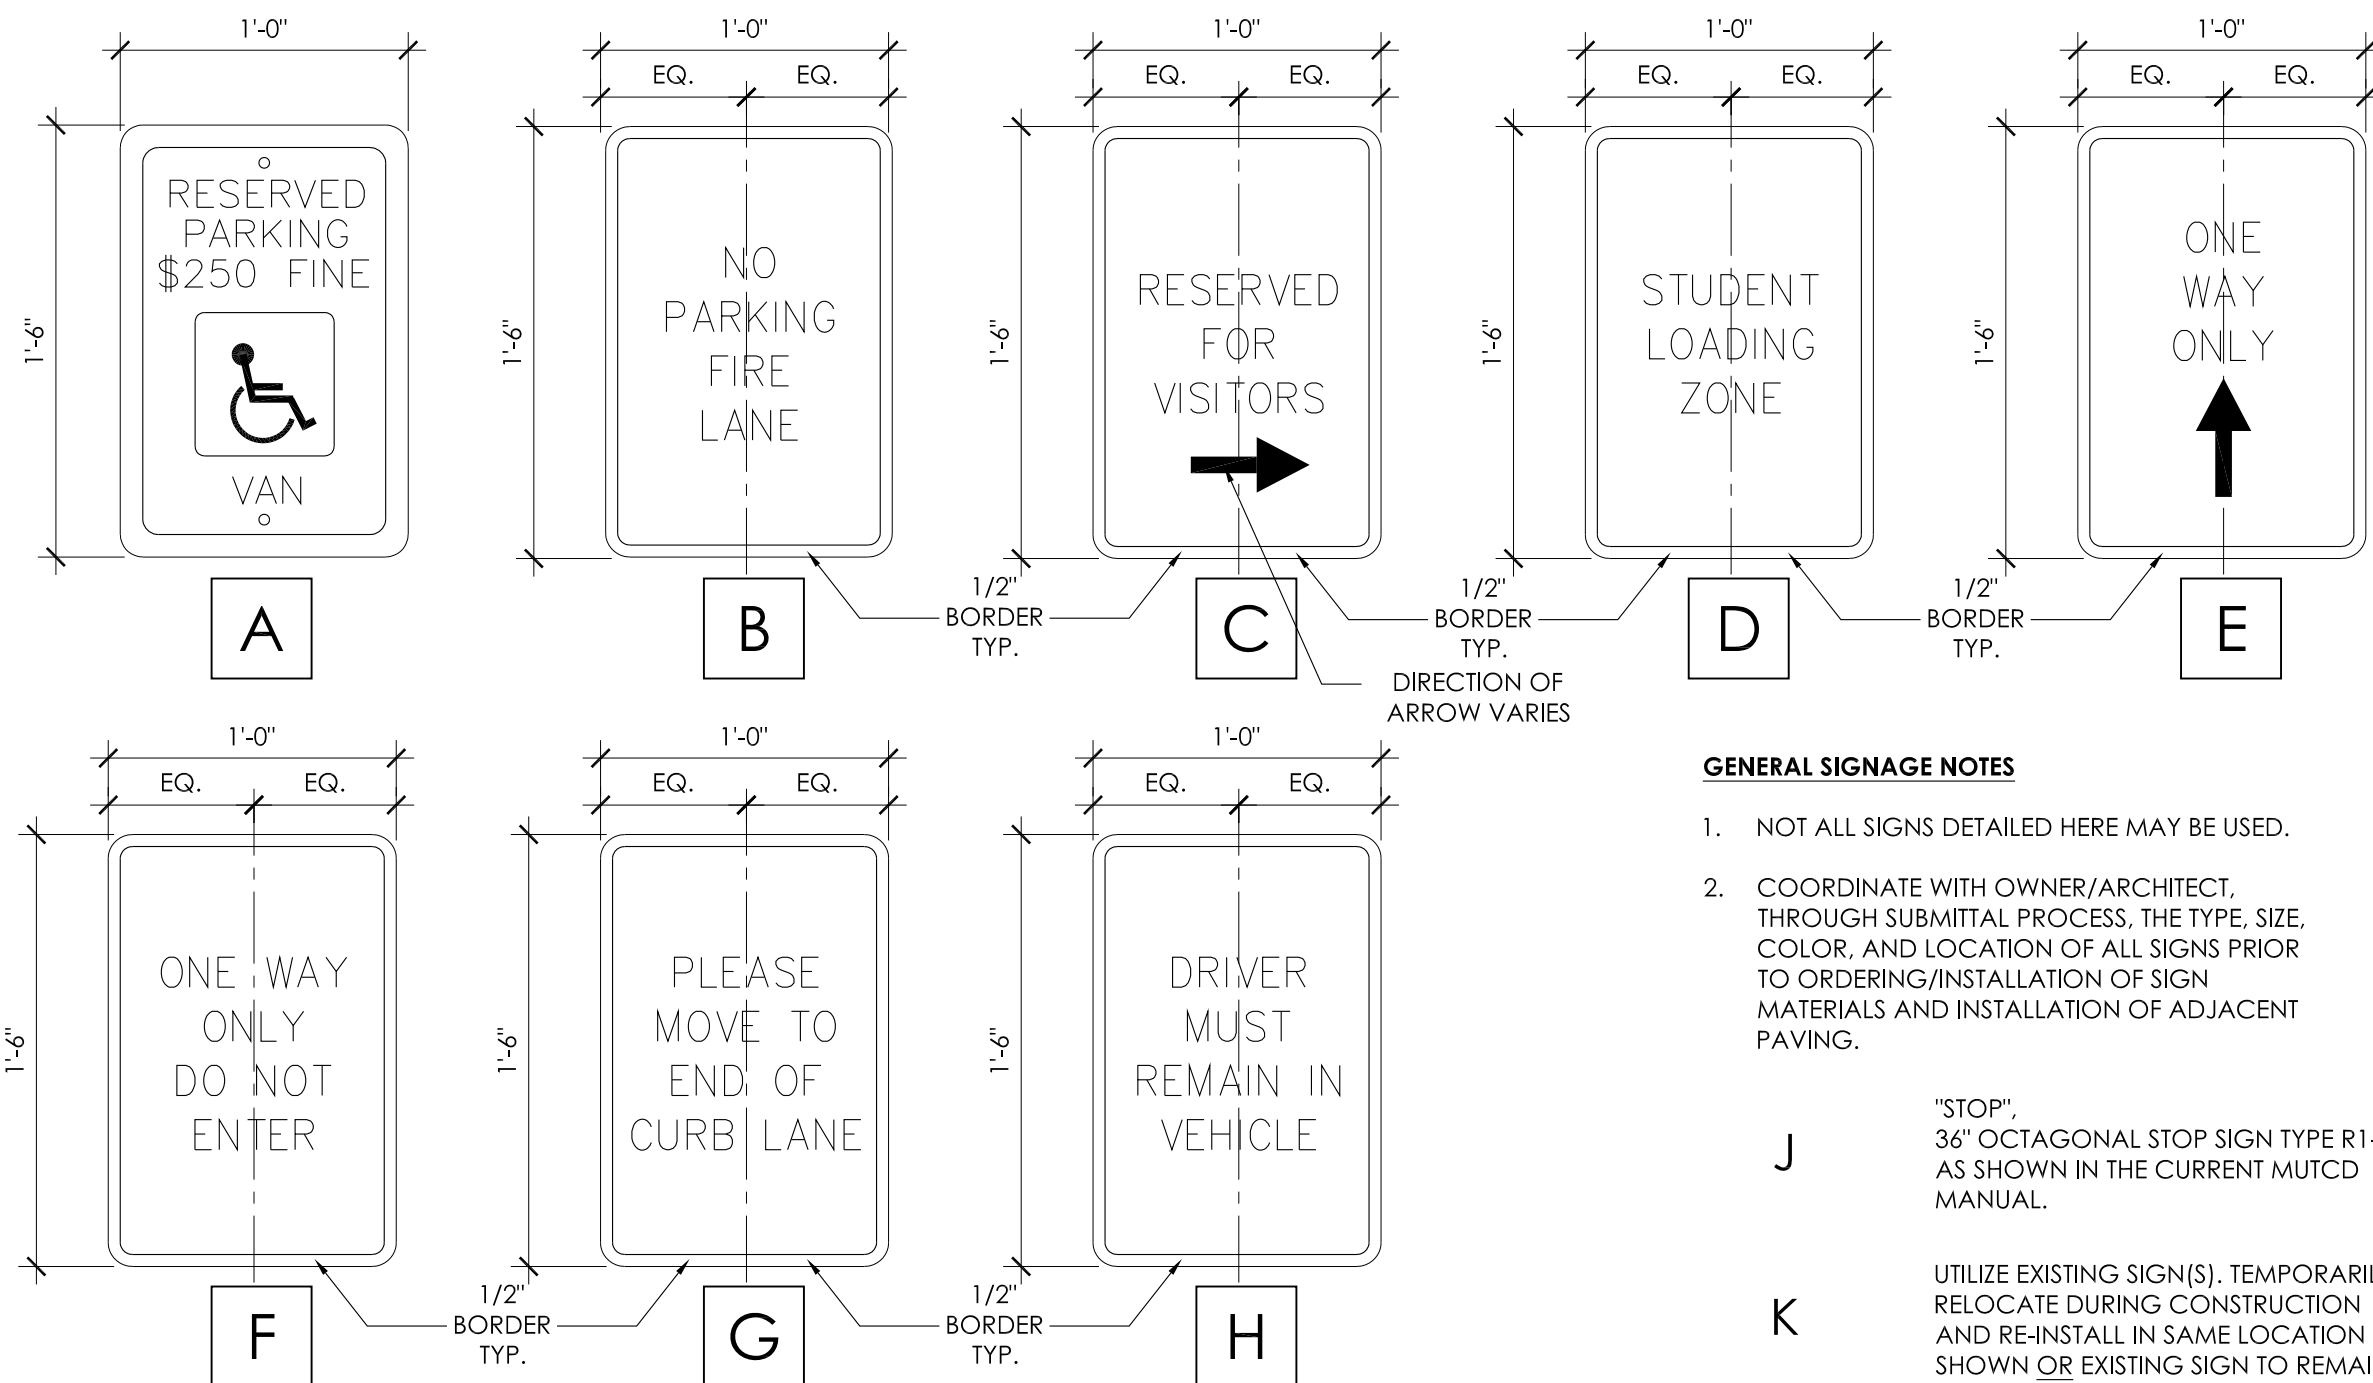

3 SIGN PANEL DESCRIPTION & SCHEDULE
A3.2 SCALE: 1 1/2" = 1'-0"

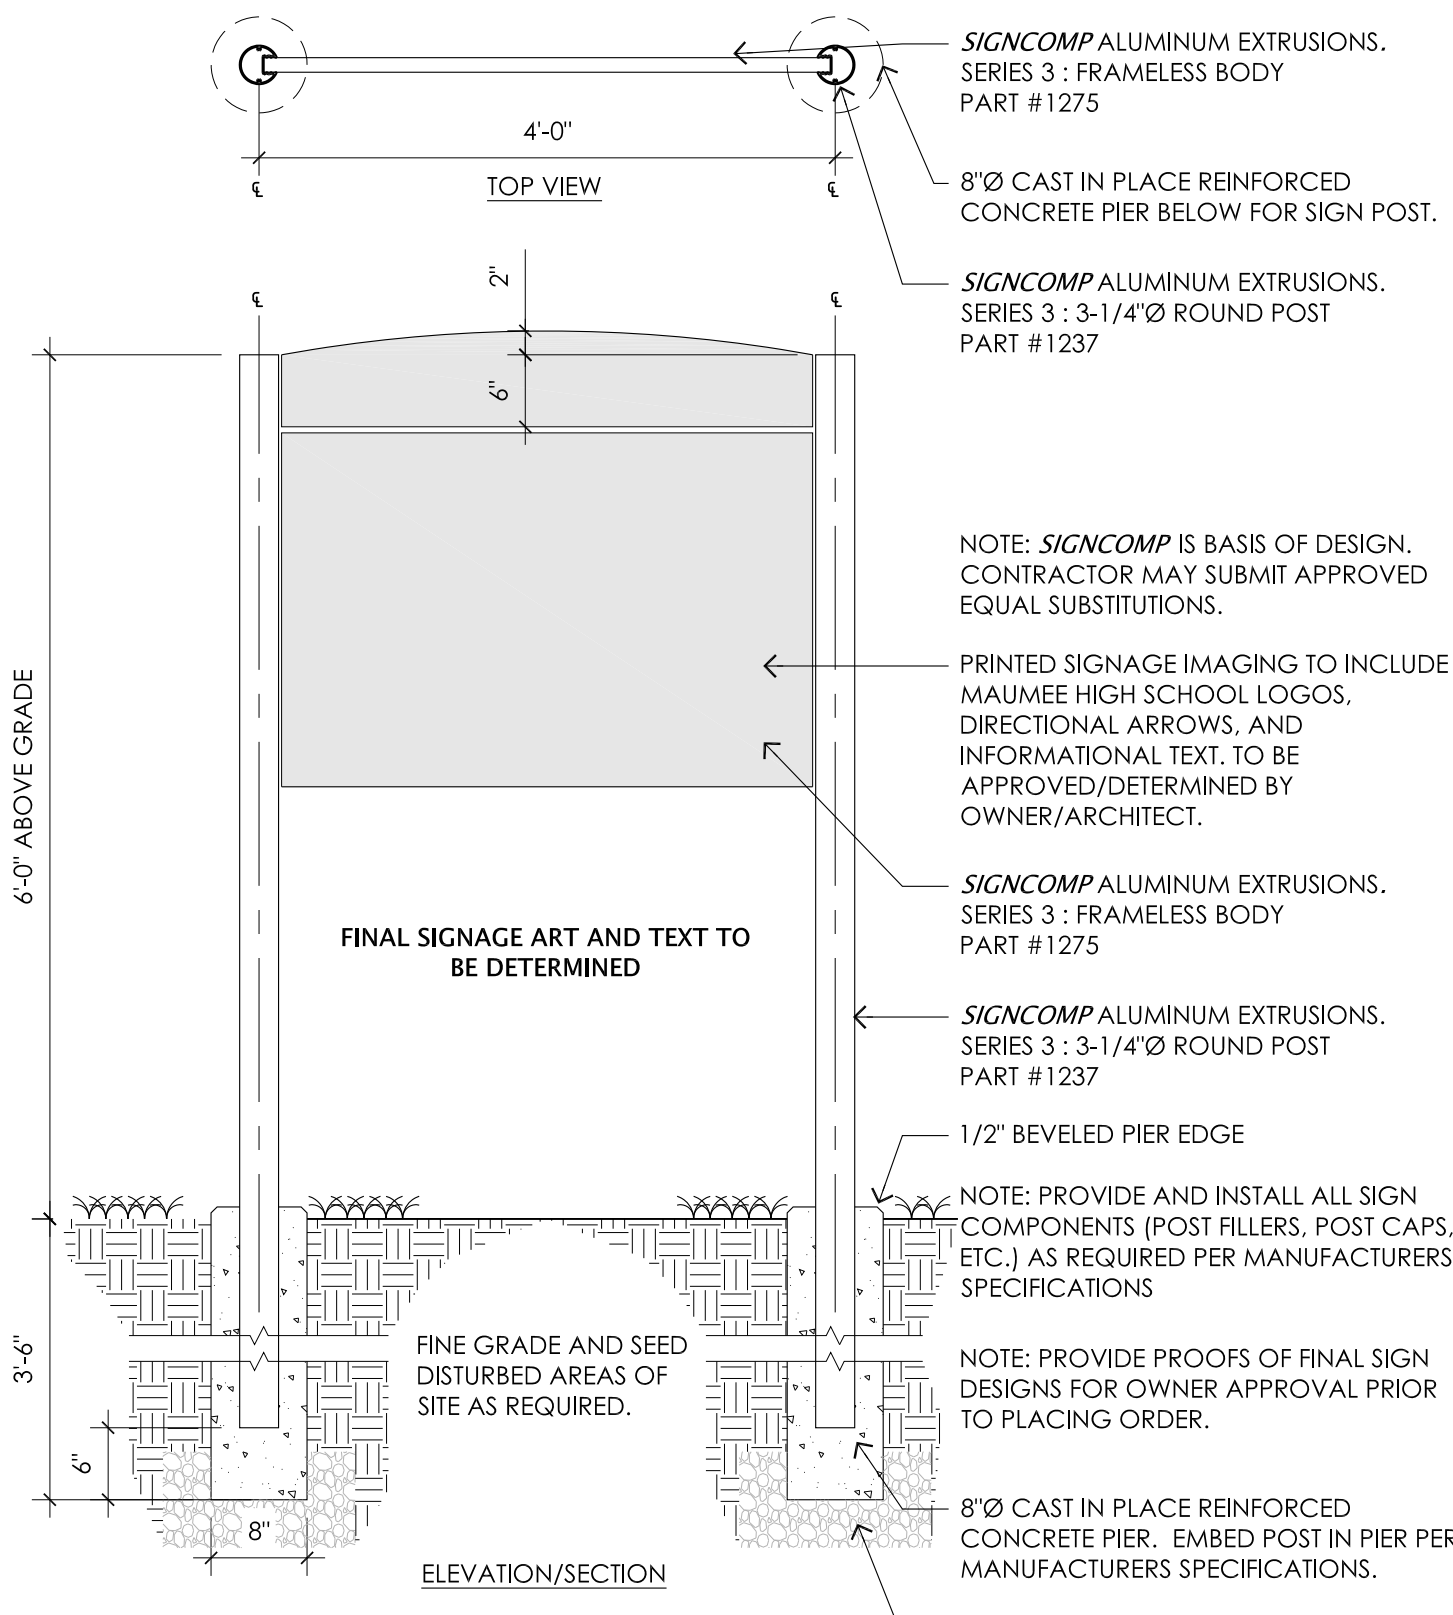

6 SIGNAGE DETAIL - FAIRFIELD
A3.2 SCALE: 3/4" = 1'-0"

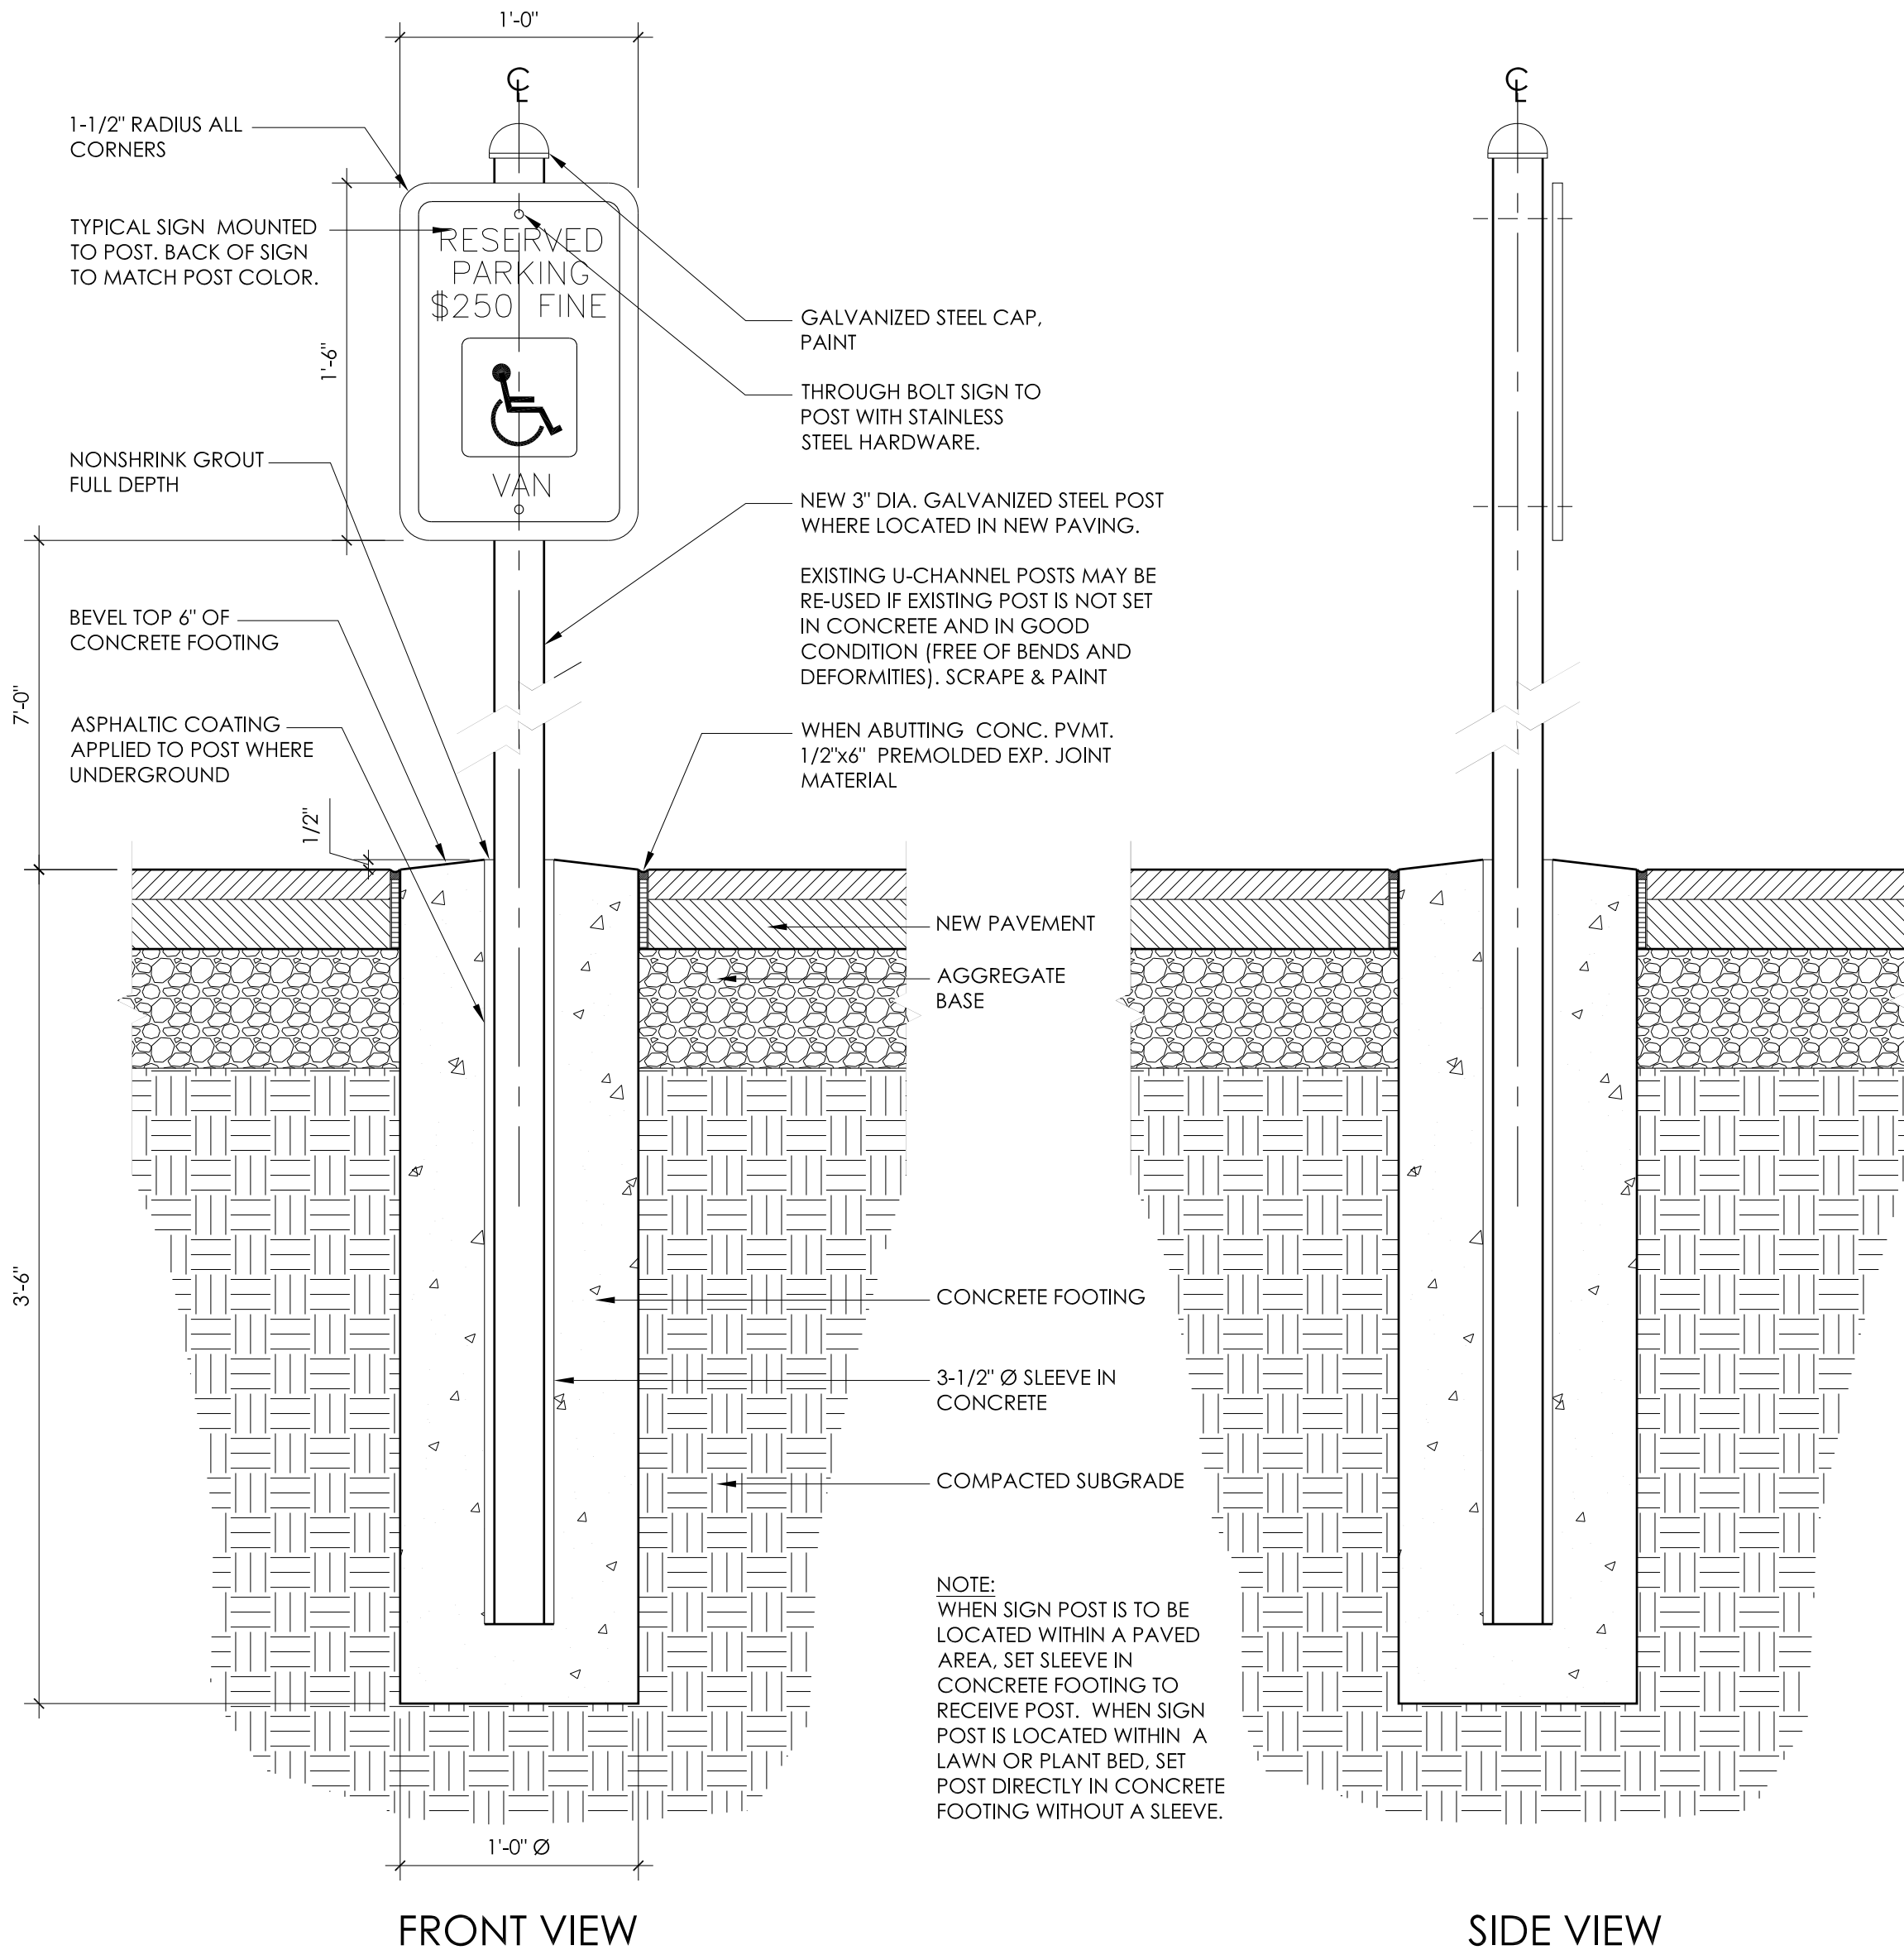

4 SIGNAGE DETAILS
A3.2 SCALE: 1 1/2" = 1'-0"

GENERAL SITE PLAN NOTES:

1. THE LOCATION OF ALL UNDERGROUND UTILITIES IS APPROXIMATE. THE EXACT LOCATION OF ANY UNDERGROUND UTILITIES SHALL BE THE CONTRACTOR'S RESPONSIBILITY. THE CONTRACTOR SHALL CONTACT THE OHIO UTILITIES PROTECTION SERVICE (OUPS, 1-800-362-2764) AT LEAST TWO (2) WORKING DAYS PRIOR TO COMMENCING WORK. NON-MEMBERS MUST BE CALLED DIRECTLY.
2. EACH CONTRACTOR SHALL NOTIFY THE OWNER'S REPRESENTATIVE IMMEDIATELY IF A DISCREPANCY IS FOUND BETWEEN THE DIMENSIONS GIVEN IN EACH DISCIPLINE DRAWING AND ACTUAL DIMENSIONS IN THE FIELD.
3. ALL LAYOUT TO BE BY A REGISTERED SURVEYOR OR ENGINEER. THE OWNER'S REPRESENTATIVE WILL REVIEW THE LAYOUT FOR GENERAL CONFORMANCE PRIOR TO CONSTRUCTION.
4. CONTRACTOR TO COORDINATE STAGING AREA WITH OWNER REPRESENTATIVE PRIOR TO MOBILIZING.
5. ALL DEMOLITION MATERIAL TO BE DISPOSED OF LEGALLY, OFF SITE, UNLESS SPECIFICALLY NOTED OTHERWISE.
6. CONTRACTOR SHALL PROVIDE TEMPORARY BARRIERS AT LIMITS OF CONSTRUCTION TO ASSURE PUBLIC SAFETY DURING CONSTRUCTION.
7. CONTRACTOR MUST MAINTAIN ACCESS TO SITE AT ALL TIMES.
8. EXTERIOR PAVEMENT ELEVATIONS TO BE FLUSH W/ EXISTING PAVEMENT ELEVATIONS U.N.O. SEE GRADING PLANS
9. CONTRACTOR TO INSURING POSITIVE DRAINAGE ACROSS ALL SURFACES.
10. FINE GRADE AND SEED OR MULCH AREAS DISTURBED BY CONSTRUCTION.
11. CONFIRM ALL EXISTING & PROPOSED GRADES PRIOR TO ANY CONSTRUCTION.
12. ALL PROPOSED GRADES ARE TO MEET AND BLEND WITH EXISTING GRADES AT LIMIT OF WORK.
13. ALL EXCESS CUT MATERIAL SHALL BE STOCKPILED IN A OWNER SPECIFIED LOCATION FOR THE DURATION OF CONSTRUCTION, AND THEN REMOVED/HAULED OFF SITE AND DISPOSED OF LEGALLY AT THE COMPLETION OF THE PROJECT UNLESS NOTED OTHERWISE.
14. THE SITE SHALL BE KEPT TIDY AND CLEAR OF MISCELLANEOUS CONSTRUCTION DEBRIS AT THE END OF EACH WORKING DAY. THE SITE SHALL BE CLEARED OF ALL DEBRIS AT THE COMPLETION OF THE PROJECT.
15. REMOVE ALL EXCESS DEBRIS FROM THE PROJECT SITE, SWEEP CLEAN ALL PAVED / FINISHED SURFACES PERIODICALLY AND AT END OF PROJECT.




8 North St. Clair - Toledo, Ohio 43604-1028
1 419.243.2400
www.thomasporterarchitects.com

CONSULTANTS:

esa
Engineers, Surveyors & Associates, LLC
5353 Secor Rd., Toledo, Ohio 43623 Phone (419) 475-9445

SEAL:

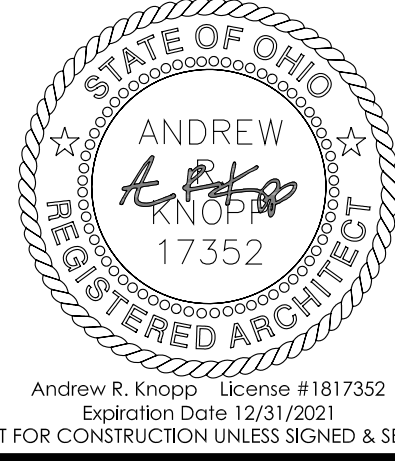

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PROJECT TITLE:

ISSUE OR REVISION:

03.05.2020 BID DOCUMENTS

DATE ISSUE / REVISION

DESIGNED: ACH

DRAWN: ACH

CHECKED: JEA

TPA COMMISSION NUMBER: 19060

DRAWING TITLE:

NOTES AND
DETAILS

DRAWING NUMBER:

A3.2

AS INDICATED BY SH

SUMMER PAVING PROJECTS
MAUMEE CITY SCHOOLS

WAYNE TRAIL ELEMENTARY
1147 7TH STREET
MAUMEE, OHIO 43537

FAIRFIELD ELEMENTARY
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